
DEVELOPER
GA FARM CREDIT
101 FORREST AVE.
CARTERSVILLE, GA 30120
(770)-382-3637

# GEORGIA FARM CREDIT NEW BRANCH OFFICE

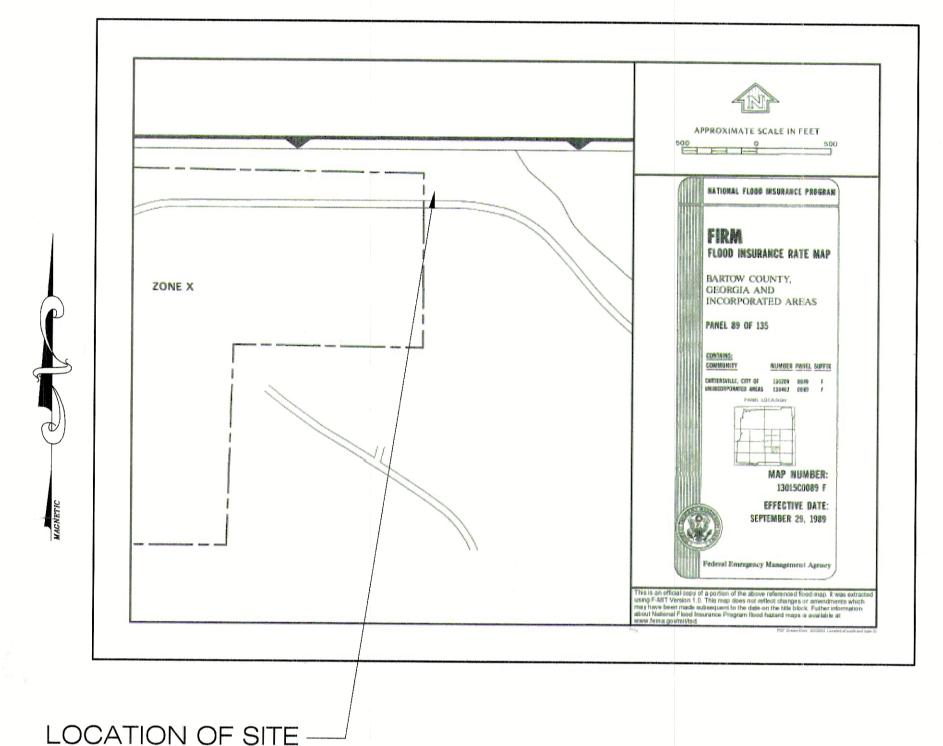

# FLOOD MAP

NOTE: SITE AREA IS NOT LOCATED IN 100 YEAR FLOODPLAIN AS PER FEMA FLOOD INSURANCE MAP # 13015C 0089 F, SEPTEMBER 29, 1989

# LAND LOT 390 4th DISTRICT, 3rd SECTION BARTOW COUNTY, GEORGIA

FEB 5, 2004

#### SHEET INDEX

CO.O GENERAL NOTES AND COVER SHEET

C1.1 EXISTING CONDITIONS

C2.1 SITE PLAN/UTILITY
C2.2 GDOT ENTRANCE PLAN


C3.1 GRADING & DRAINAGE PLAN

C4.1 EROSION CONTROL PLAN

C5.1 EROSION DETAILS

C6.1 PROFILES

C7.1 DETAILS

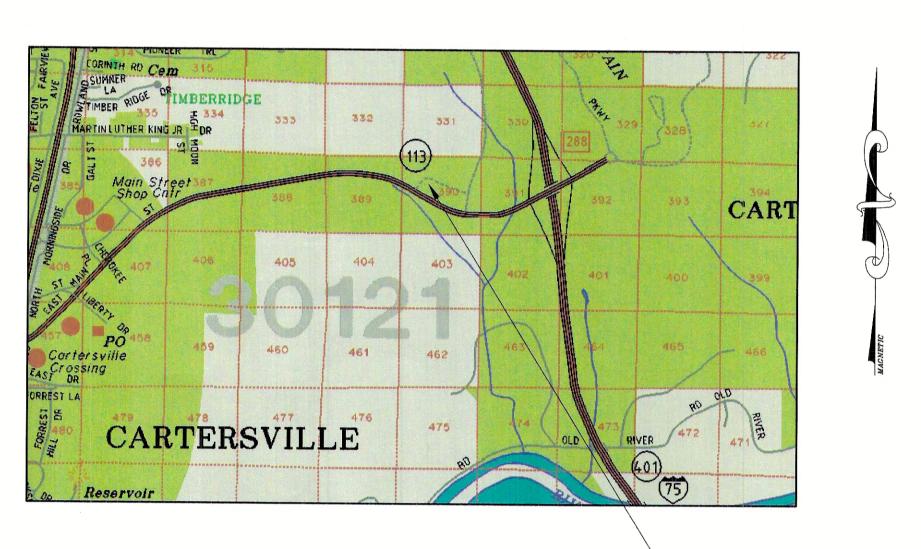

VICINITY MAP LOCATION OF SITE

NITS

24 HR CONTACT HAL REGAN (770)-382-3637

#### **GENERAL NOTES**

ALL SILT BARRIERS MUST BE PLACED AS ACCESS IS OBTAINED DURING CLEARING. NO GRADING SHALL BE DONE UNTIL SILT BARRIER INSTALLATION IS CONSTRUCTED.

SILT BARRIERS TO BE PLACED AS SHOWN AND/OR AS DIRECTED BY PROJECT ENGINEER AND/OR THE CITY INSPECTOR.

NOTIFY INSPECTOR 24 HOURS PRIOR TO CONSTRUCTION.

ALL EROSION AND SEDIMENTATION CONTROLS, AND

PRIOR TO GRADING.

ACCEPTED PLANS AND SUBSEQUENT ACCEPTED REVISIONS MUST BE PRESENT ON—SITE AT ALL TIMES.

TREE PROTECTION MEASURES SHALL BE INSTALLED

ACCEPTANCE OF THESE PLANS BY THE CITY DOES NOT RELIEVE PERMIT HOLDER FROM MEETING ALL REQUIREMENTS OF THE "CITY OF ADAIRSVILLE ORDINANCE", "FLOOD DAMAGE PREVENTION ORDINANCE", "SOIL EROSION AND SEDIMENTATION CONTROL ORDINANCE", THE RULES AND REGULATIONS OR THE THE CITY HEALTH DEPARTMENT, THE US ARMY CORPS OF ENGINEERS AND ANY OTHER LOCAL, STATE, OR FEDERAL LAW OR REGULATION AS IT RELATES TO DEVELOPMENT IN ADAIRSVILLE..

THE\_LOCATION OF EROSION AND SEDIMENT CONTROL DEVICES MAY HAVE TO BE ALTERED FROM THAT SHOWN ON THE ACCEPTED PLANS DUE TO CHANGES IN DRAINAGE PATTERS CREATED DURING CONSTRUCTION. IT IS THE OWNER/DEVELOPER'S RESPONSIBILITY TO ACCOMPLISH EROSION AND SEDIMENT CONTROL FOR ALL DRAINAGE PATTERS CREATED AT VARIOUS STATES DURING CONSTRUCTION. ANY DIFFICULTY IN CONTROLLING EROSION OR SEDIMENT DURING ANY PHASE OF CONSTRUCTION SHALL BE REPORTED TO THE PROJECT ENGINEER IMMEDIATELY. FAILURE TO PROPERLY INSTALL, OPERATE OR MAINTAIN ALL EROSION AND SEDIMENTATION CONTROL MEASURES MAY RESULT IN ALL CONSTRUCTION BEING STOPPED UNTIL SUCH MEASURES ARE CORRECTED TO THE SATISFACTION OF THE CITY INSPECTOR

EROSION CONTROL MEASURES WILL BE INSPECTED AT LEAST WEEKLY AND AFTER EACH RAIN, AND REPAIRED BY GENERAL CONTRACTOR.

DETENTION/SEDIMENT POND(S) AND DIVERSION DITCHES SHALL BE INSTALLED IMMEDIATELY AFTER CLEARING FOR ROADWAY CONSTRUCTION. DETENTION POND(S) SHALL BE RETROFITTED FOR SILTATION CONTROL. ENGINEER SHALL IMMEDIATELY FOLLOW—UP WITH AS—BUILT CERTIFICATION FOR DESIGN COMPLIANCE PRIOR TO ACCEPTANCE OF FINAL PLAT.

OWNER AGREES BY IMPLEMENTATION OF THESE PLANS THAT ALL LAND CLEARING, CONSTRUCTION, DEVELOPMENT AND DRAINAGE ACTIVITIES WILL BE DONE ACCORDING TO THESE ACCEPTED PLANS OR PREVIOUSLY ACCEPTED REVISIONS. OWNER ACKNOWLEDGES THAT ACCEPTANCE OF PLANS BY THE COUNTY IN NO WAY RELIEVES OWNER OF RESPOSIBILITY NOT TO ADVERSELY IMPACT DOWNSTREAM PROPERTY REGARDING ANY LAND DISTURBING ACTIVITY, EROSION AND SEDIMENT CONTROL MEASURE AND/OR STORMWATER MANAGEMENT ACTIVITY DURING OR AFTER CONSTRUCTION. OWNER ADKNOWLEDGES THAT THE ACCEPTANCE OF THESE PLANS AND THE ISSUANCE OF THIS LAND DISTURBANCE PERMIT DOES NOT IN ANY WAY SUGGEST THAT ALL OTHER REQUIREMENTS FOR THE LEGAL OR APPROPRIATE OPERATIONS FOR THIS ACTIVITY, WHICH MAY REQUIRE ADDITIONAL PERMITTING OR APPROVALS MAY BE NECESSARY IF ANY TO OPERATE FROM THIS POINT IN AN APPROPRIATE AND LEGAL MANNER. PLAN ACCEPTANCE OR PERMIT ISSUANCE DOES NOT ABSOLVE THE APPLICANT FROM COMPLYING WITH ALL APPLICABLE LAWS, POLICIES, STANDARDS OR OTHER PERMITS WHICH MAY BE REQUIRED FOR THIS PROJECT.

ANY AND ALL LAND DISTUBANCE PERMITS MAY BE REVOKED AT ANY TIME IF THE CONSTRUCTION OF PROJECT IS NOT IN STRICT ACCORDANCE WITH ACCEPTED PLANS.

DRAINAGE EASEMENTS WILL BE PROVIDED ALONG ALL CONCENTRATED DRAINAGE PATHS A MINIMUM WIDTH OF 20'. REQUIRED WIDTHS AND LOCATIONS WILL BE REFERENCED AND SHOWN OF FINAL PLAT.. PROPOSED DRAINAGE DITCHES WILL BE PROVIDED WITH PRIVATELY OWNED EASEMENTS AND ARE TO BE MAINTAINED AND PROTECTED BY INDIVIDUAL LOT OWNERS. NOTICE OF SAME SHALL BE INCLUDED ON FINAL PLAT AND SUBSEQUENT DEEDS OF CONVEYANCE FROM THE DEVELOPER TO THE INDIVIDUAL LOT OWNERS. OPEN DRAINAGE DITCHES SHALL BE 4:1 SIDE SLOPES OR FLATTER AND FALL ENTIRELY WITHIN EASEMENT. RESIDENTIAL FENCES AND OTHER FLOW OBSTRUCTIONS AR NOT ALLOWED WITHIN DRAINAGE EASEMENTS.

THE PERFORMANCE OF ALL STORM WATER DRAINAGE SYSTMENS INCLUDING DETENTION FACILITIES HAVE BEEN CHECKED USING THE 100—YEAR STORM (DEVELOPED CONDITION) FOR EVALUATION OF LOCAL FLOODING AND POSSIBLE FLOOD HAZARDS TO ADJACENT STRUCTURES AND/OR PROPERTY. THE CUMULATIVE EFFECT OF THE PROPOSED DEVELOPMENT, WHEN COMBINED WITH ALL OTHER EXISTING AND ANTICIPATED DEVELOPMENT WILL NOT INCREASE THE WATER SURFACE ELEVATION OF THE BASE FLOOD MORE THAN ON FOOT AT ANY POINT

IF ACTUAL SITE CONDITIONS VARY FROM ACCEPTED PLANS, IT IS THE OWNER/DEVELOPERS RESPONSIBILITY TO INFORM THE ENGINEER OF RECORD AND THE COUNTY ZONING ADMINISTRATOR FOR ASSESSMENT OF CONDITION. PROJECT CONSTRUCTION MAY BE DELAYED DURING ASSESSMENT PERIOD.

ACCEPTANCE OF THESE PLANS DOES NOT CONSTITUTE APPROVAL BY THE CITY OF ANY LAND DISTURBING ACTIVITY WITHIN WETLAND AREAS. IT IS THE OWNER'S RESPONSIBILITY TO CONTACT THE APPROPRIATE REGULATORY AGENCY FOR APPROVAL OF ANY WETLAND AREA DISTURBANCE.

IT IS THE OWNER'S RESPONSIBILITY TO ENSURE THAT ALL COMMERCIAL LOTS HAVE SUFFICIENT GRADE AND ADEQUATE DRAINAGE TO PREVENT FLOODING OF PROPOSED STRUCTURES AND PERTINENT IMPROVEMENTS SUCH AS ON—SITE SEPTIC SYSTEMS. DEVELOPER SHALL NOTIFY BUILDER OF ANY SPECIAL CONDITIONS RELATING TO LOT DRAINAGE AND FLOODING POTENTIAL.

DEED RESTRICTIONS ARE REQUIRED FOR LOTS AFFECTED BY DETENTION POND(S) TO PROTECT POND FROM UNAUTHORIZED USE OR ACTIVITY. THE OWNER SHALL GRANT TOTHE CITY, A PERPETUAL, NON-EXCLUSIVE EASEMENT WHICH ALLOWS FOR PUBLIC INSPECTION/MAINTENANCE AND EMERGENCY REPAIR FOR THE DETENTION POND(S). THE EASEMENTS SHALL BE RECORDED WITH THE CLERK OF SUPERIOR COURT OF BARTOW COUNTY PRIOR TO ACCEPTANCE OF FINAL PLAT.

DEVELOPER SHALL FURNISH, INSTALL AND MAINTAIN ALL NECESSARY TRAFFIC BARRICADES AND WARNING SIGNAGE TO THE SATISFACTION OF THE PUBLIC WORKS DEPARTMENT WHILE ROADWAY FRONTAGE IMPROVEMENTS ARE MADE.

OWNER/DEVELOPER IS RESPONSIBLE FOR MAINTAINING CONTROL OF SILT ON-SITE AT ALL TIMES. DEVELOPER IS ALSO RESPONSIBLE FOR CONTROL OF SILT THAT IS TRACKED ONTO COUNTY R/W OR SUBDIVISION STREETS BY BUILDERS, CONTRACTORS, SUBCONTRACTORS, UTILITY COMPANIES OR ANY OTHERS DURING CONSTRUCTION UNTIL STREET HAS BEEN ACCEPTED BY COUNTY PUBLIC WORKS DEPARTMENT.

MAINTAIN A MINIMUM 2' OF COVER OVER STORM PIPES. ALL CORRUGATED METAL PIPE TO BE MAINTAINED BY COUNTY SHALL BE FULLY ASPHALT COATED. PAVED INVERTS ARE REQUIRED IN PERENNIAL STREAMS. PIPE GAGE DETERMENED BASED ON DEPTH OF COVER AND LOADING CONDITIONS.

DEBRIS FILLS ARE STRICTLY PROHIBITED AT ALL CONSTRUCTION SITES OR WITHIN ANY DEVELOPMENT. ALL WASTE AND CONSTRUCTION DEBRIS GENERATED FROM CONSTRUCTION MUST BE PROPERLY DISPOSED OF IN THE BARTOW COUNTY LANDFILL. APPROVAL OF PERMIT—BY—RULE FOR INERT LANDFILLS IS REQUIRED BY STATE D.N.R..

ALL STREET AND STOP SIGNS MUST BE INSTALLED PRIOR TO ISSUANCE OF ANY BUILDING PERMITS.

DEEDS OF DEDICATION FOR PUBLIC RIGHTS—OF—WAY, DETIENTION PONDS AND ACCESS TO DETENTION PONDS MUST BE SUBMITTED PRIOR TO ACCEPTANCE OF FINAL PLAT. THE OWNER/DEVELOPER IS RESPONSIBLE FOR RECORDING SAID DEEDS AFTER ACCEPTANCE BY THE COMMISSIONER. OWNER/DEVELOPER SHALL WARRANT THE ROADS AND/OR STREETS AND DETENTION PONDS FOR A PERIOD OF ONE YEAR FROM DATE OF ACCEPTANCE.

PROPERLY EXECUTED AND RECORDED EASEMENTS AND DEEDS OF DEDICATION MUST BE PROVIDED FOR STORM WATER MANAGEMENT FACILITIES OF SINGLE FAMILY RESIDENTIAL SUBDIVISIONS PRIOR TO THE RECORDING OF THE FINAL PLAT. FOR OTHER TYPES OF DEVELOPMENT THE RESPONSIBILITY FOR MAINTENANCE AND FUNCTIONAL INTEGRITY OF SAID FACILITIES WILL REMAIN THE RESPONSIBILITY OF THE OWNER.

TOTAL AREA = 1.0 ACRES
TOTAL DISTURBED = .97 ACRES

CALL FREE
IN METRO ATLANTA
770-623-4344
THROUGHOUT GEORGIA
1-800-282-7411
IF YOU DIG GEORGIA...
CALL US FIRST!
IT'S THE LAW!
THREE WORKING DAYS BEFORE YOU DIG

\*NOTES\*

a. Storm water detention facility(ies) shall remain in place as approved and as-built certified in perpetuity and shall not be encroached upon for any reason.
b. Detention facility(ies) shall be inspected on a semi-annual basis by owner. Any accumulated trash, sediment, or debris shall be removed and disposed of in an approved manner.

 c. Owner/Developer shall accept full liability for the safety of all persons in or around the detention facility(ies) at all times.

d. owner/Developer shall indemnify THE CITY against all suits brought about by the existance of the detention facility(ies).
e. Owner/Developer shall provide that obligations be transferred to all successors and assigns of property, and shall accept responsibility for informing such

successors and assigns of said obligations.


f. All existing and proposed storm drainage featurea affecting this development have been evaluated and/or designed in accordance with THE CITY requirements and will not adversely impact any proposed on-site improvements or upstream or downstream property.

#### ENGINEER

SOUTHLAND ENGINEERING
CONSULTING ENGINEERS
925 NORTH TENNESSEE ST.
CARTERSVILLE, GEORGIA 30120
CONTACT: MR. KARL LUTJENS
TELEPHONE: (770) 387-0440

3/1/04 1 SUBMITTAL TO GDOT
2/24/04 1 SUBMITTAL TO CITY OF CARTERSVILLE
DATE DESCRIPTION

REVISIONS

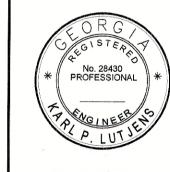

# ----

DRAWN:

CHECKED:

APPROVED:

DESIGNED

# SOUTHLAND ENGINEERING INC.


925 NORTH TENNESSEE ST. CARTERSVILLE, GA 30120 (770) 387-0440


### GA FARM CREDIT STATE ROUTE 113


LAND LOT 390, 4th DIST., 3rd SECT BARTOW COUNTY, GEORGIA


GENERAL NOTES/ COVER SHEET

PROJ. NO.:	CITY-03
DATE :	1-15-04
SCALE :	"=SCALE"
DWG. NO. ;	

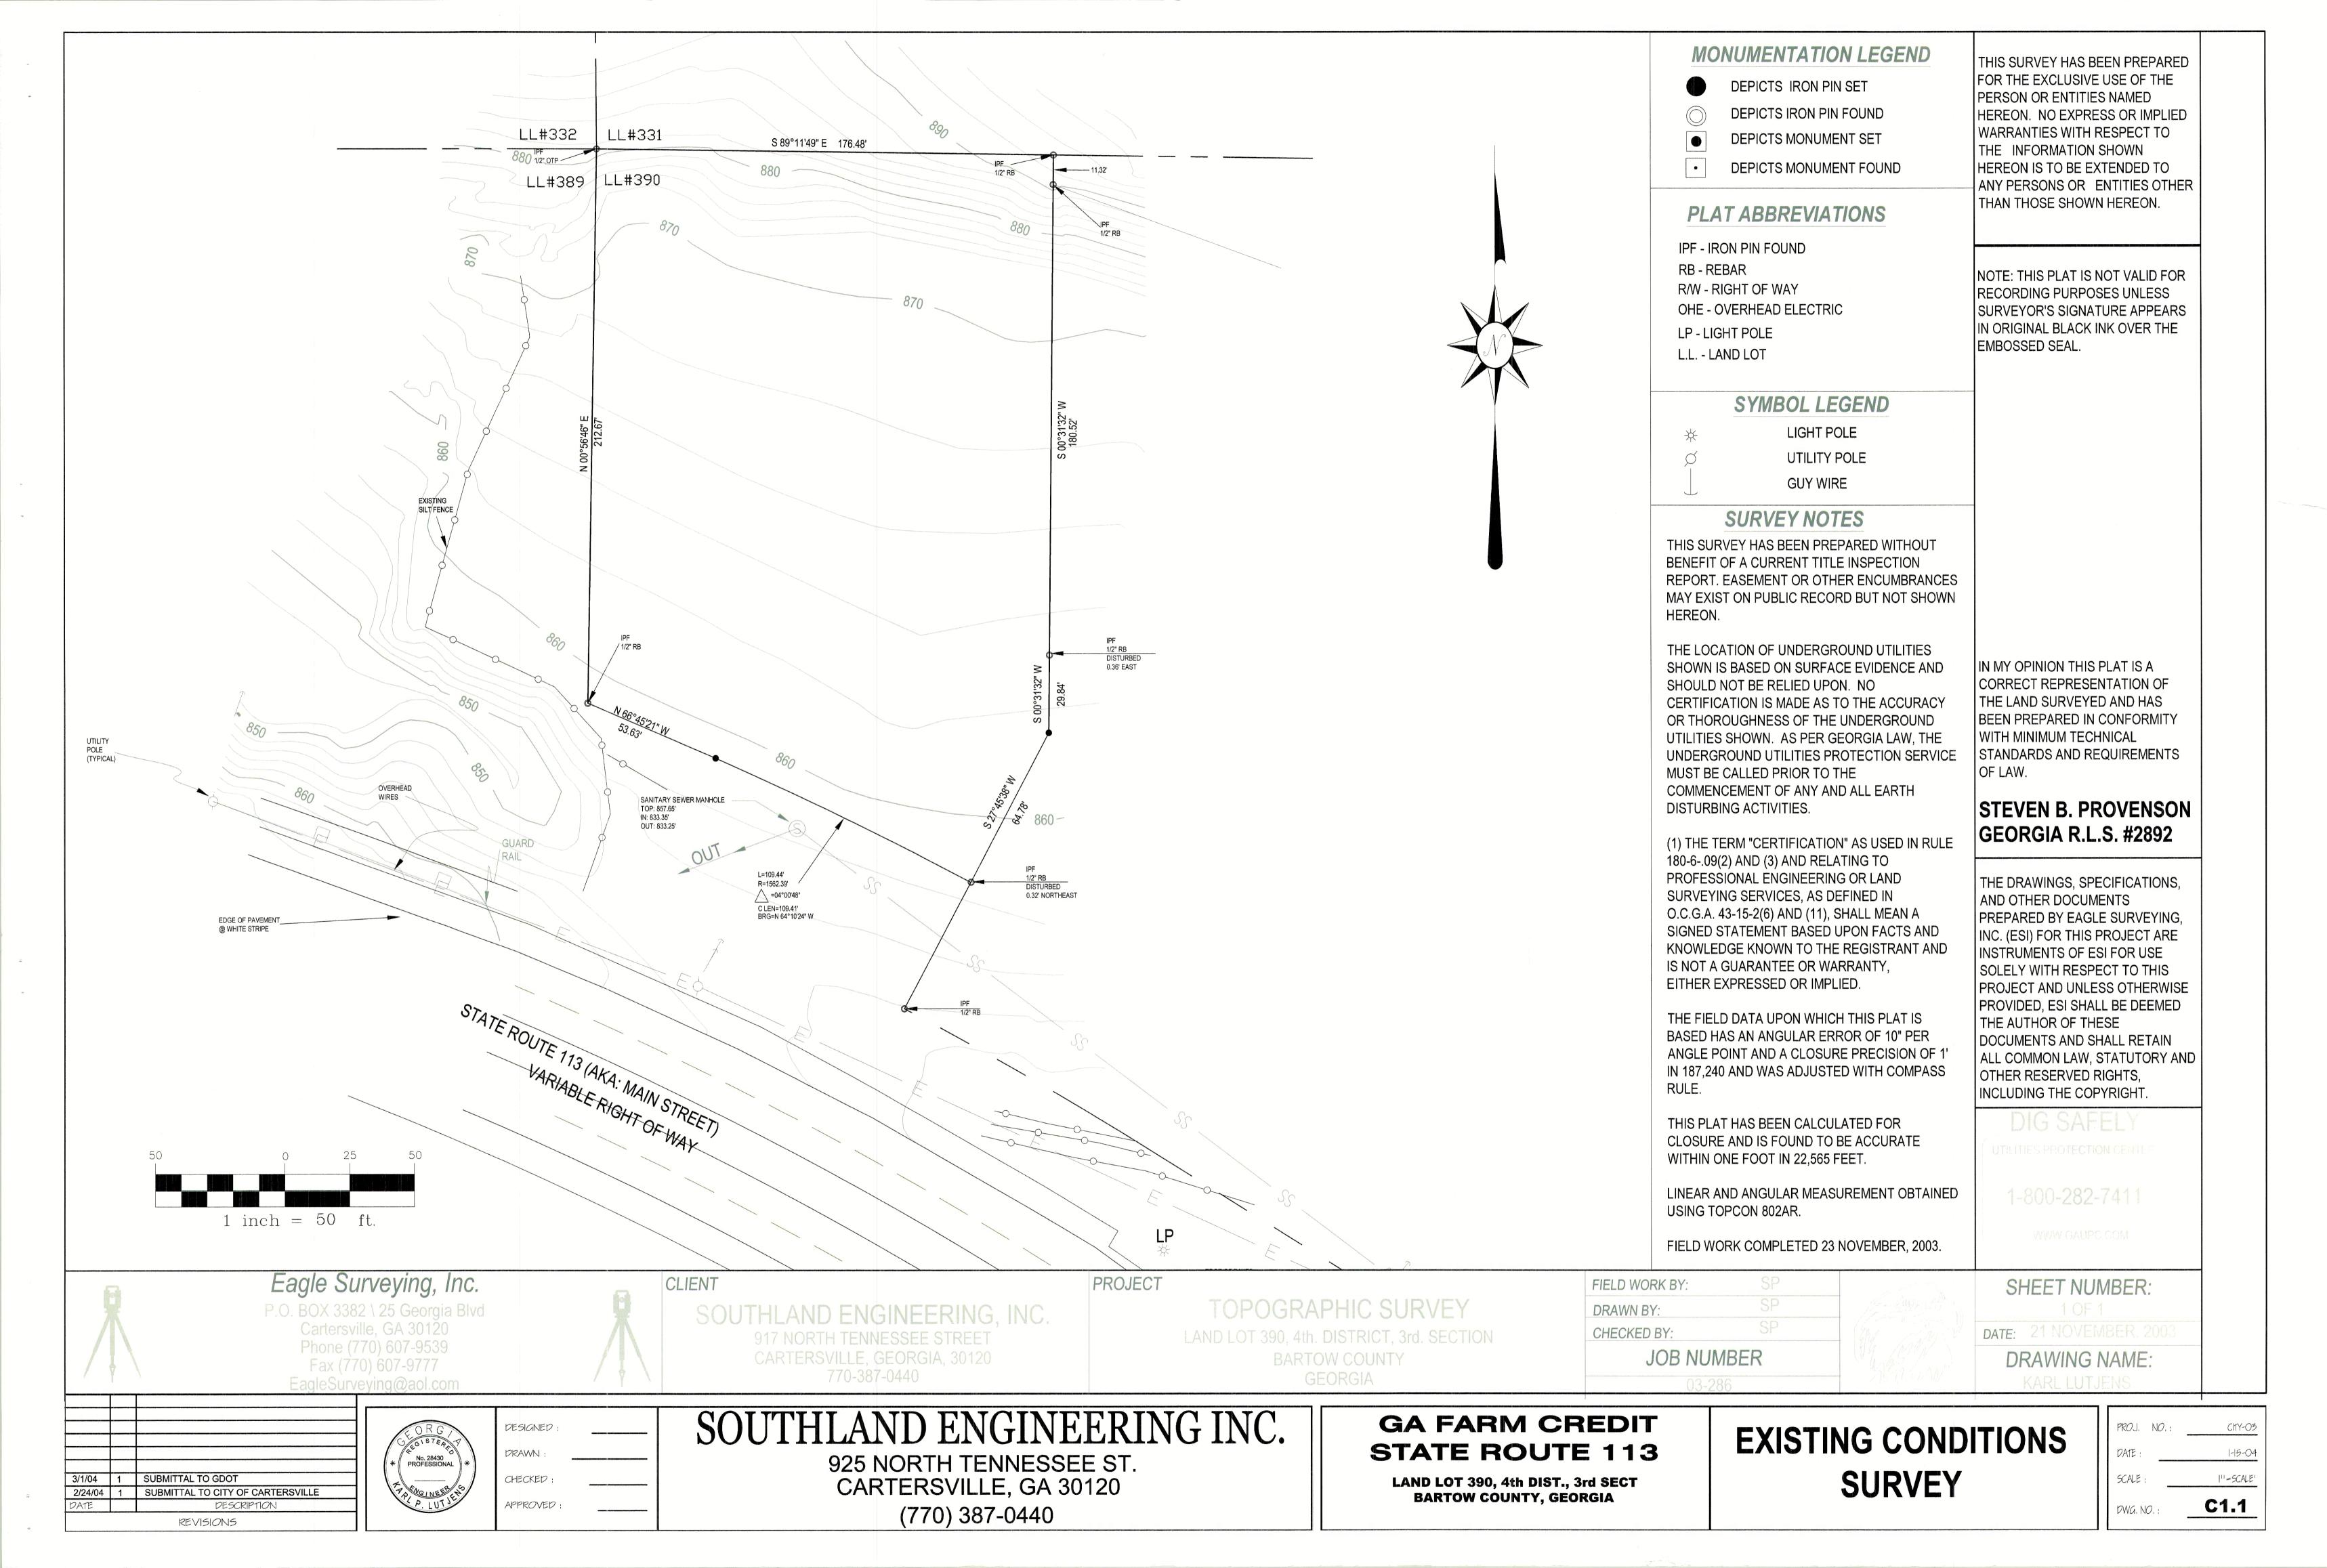

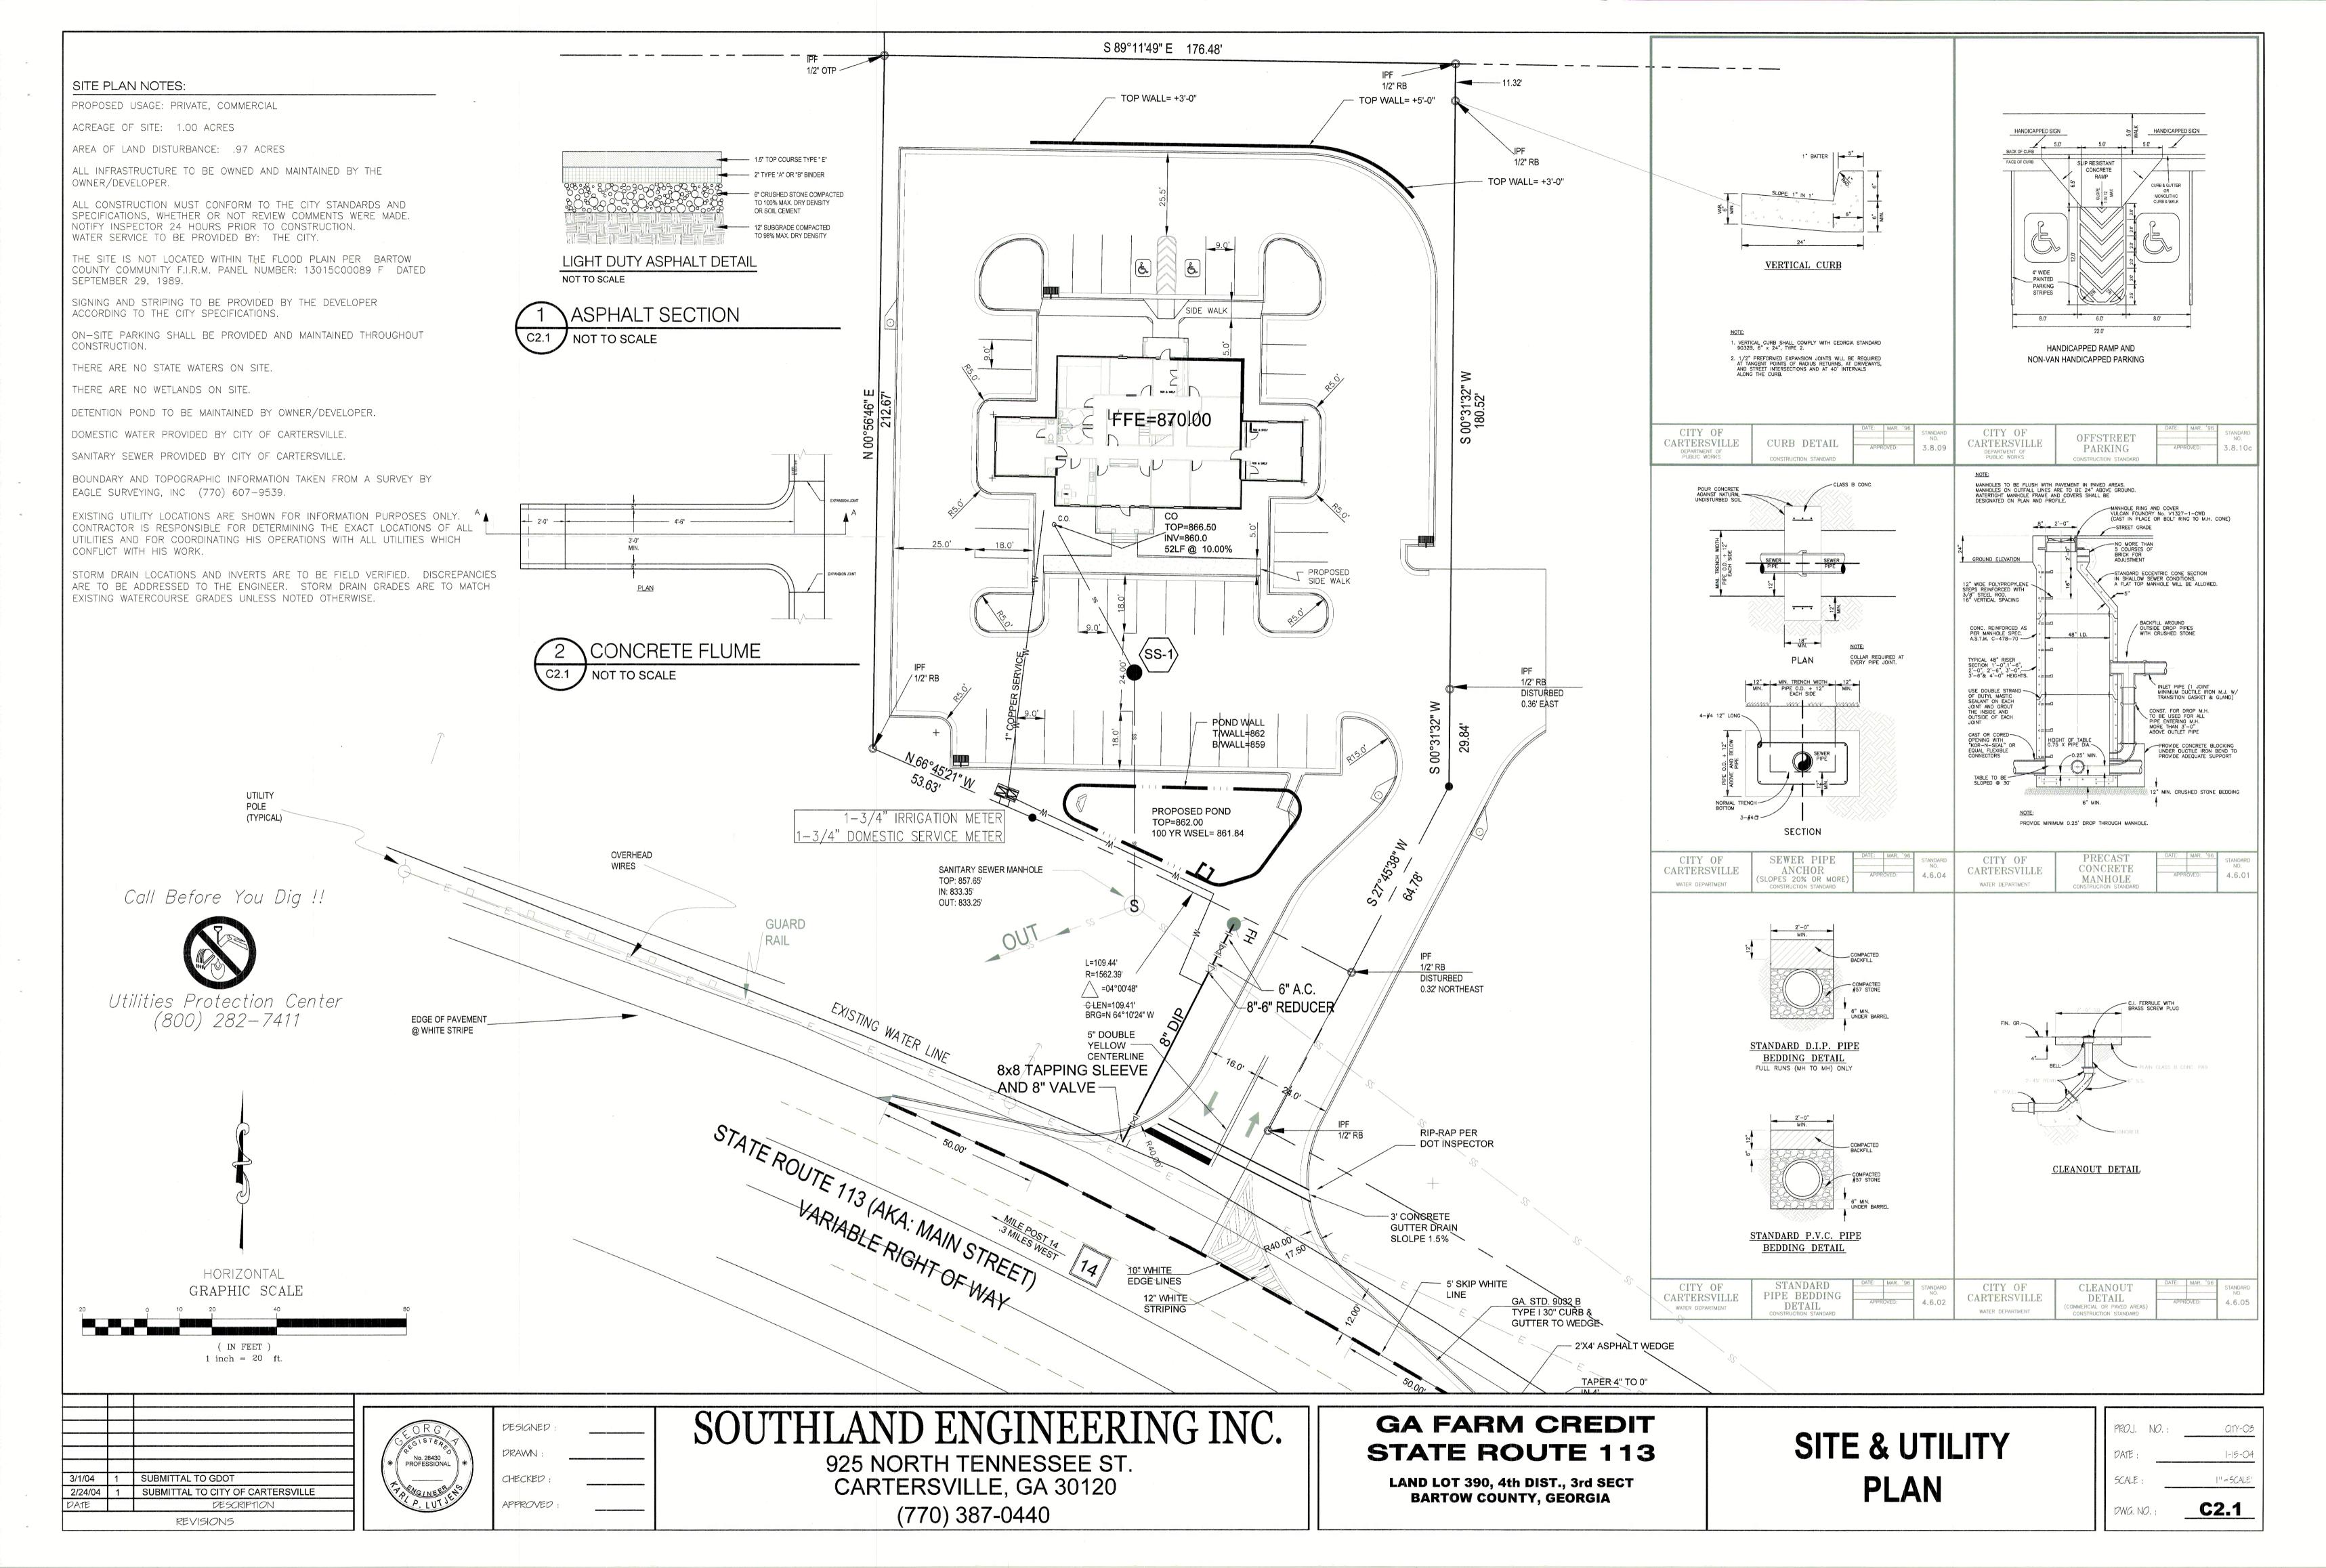

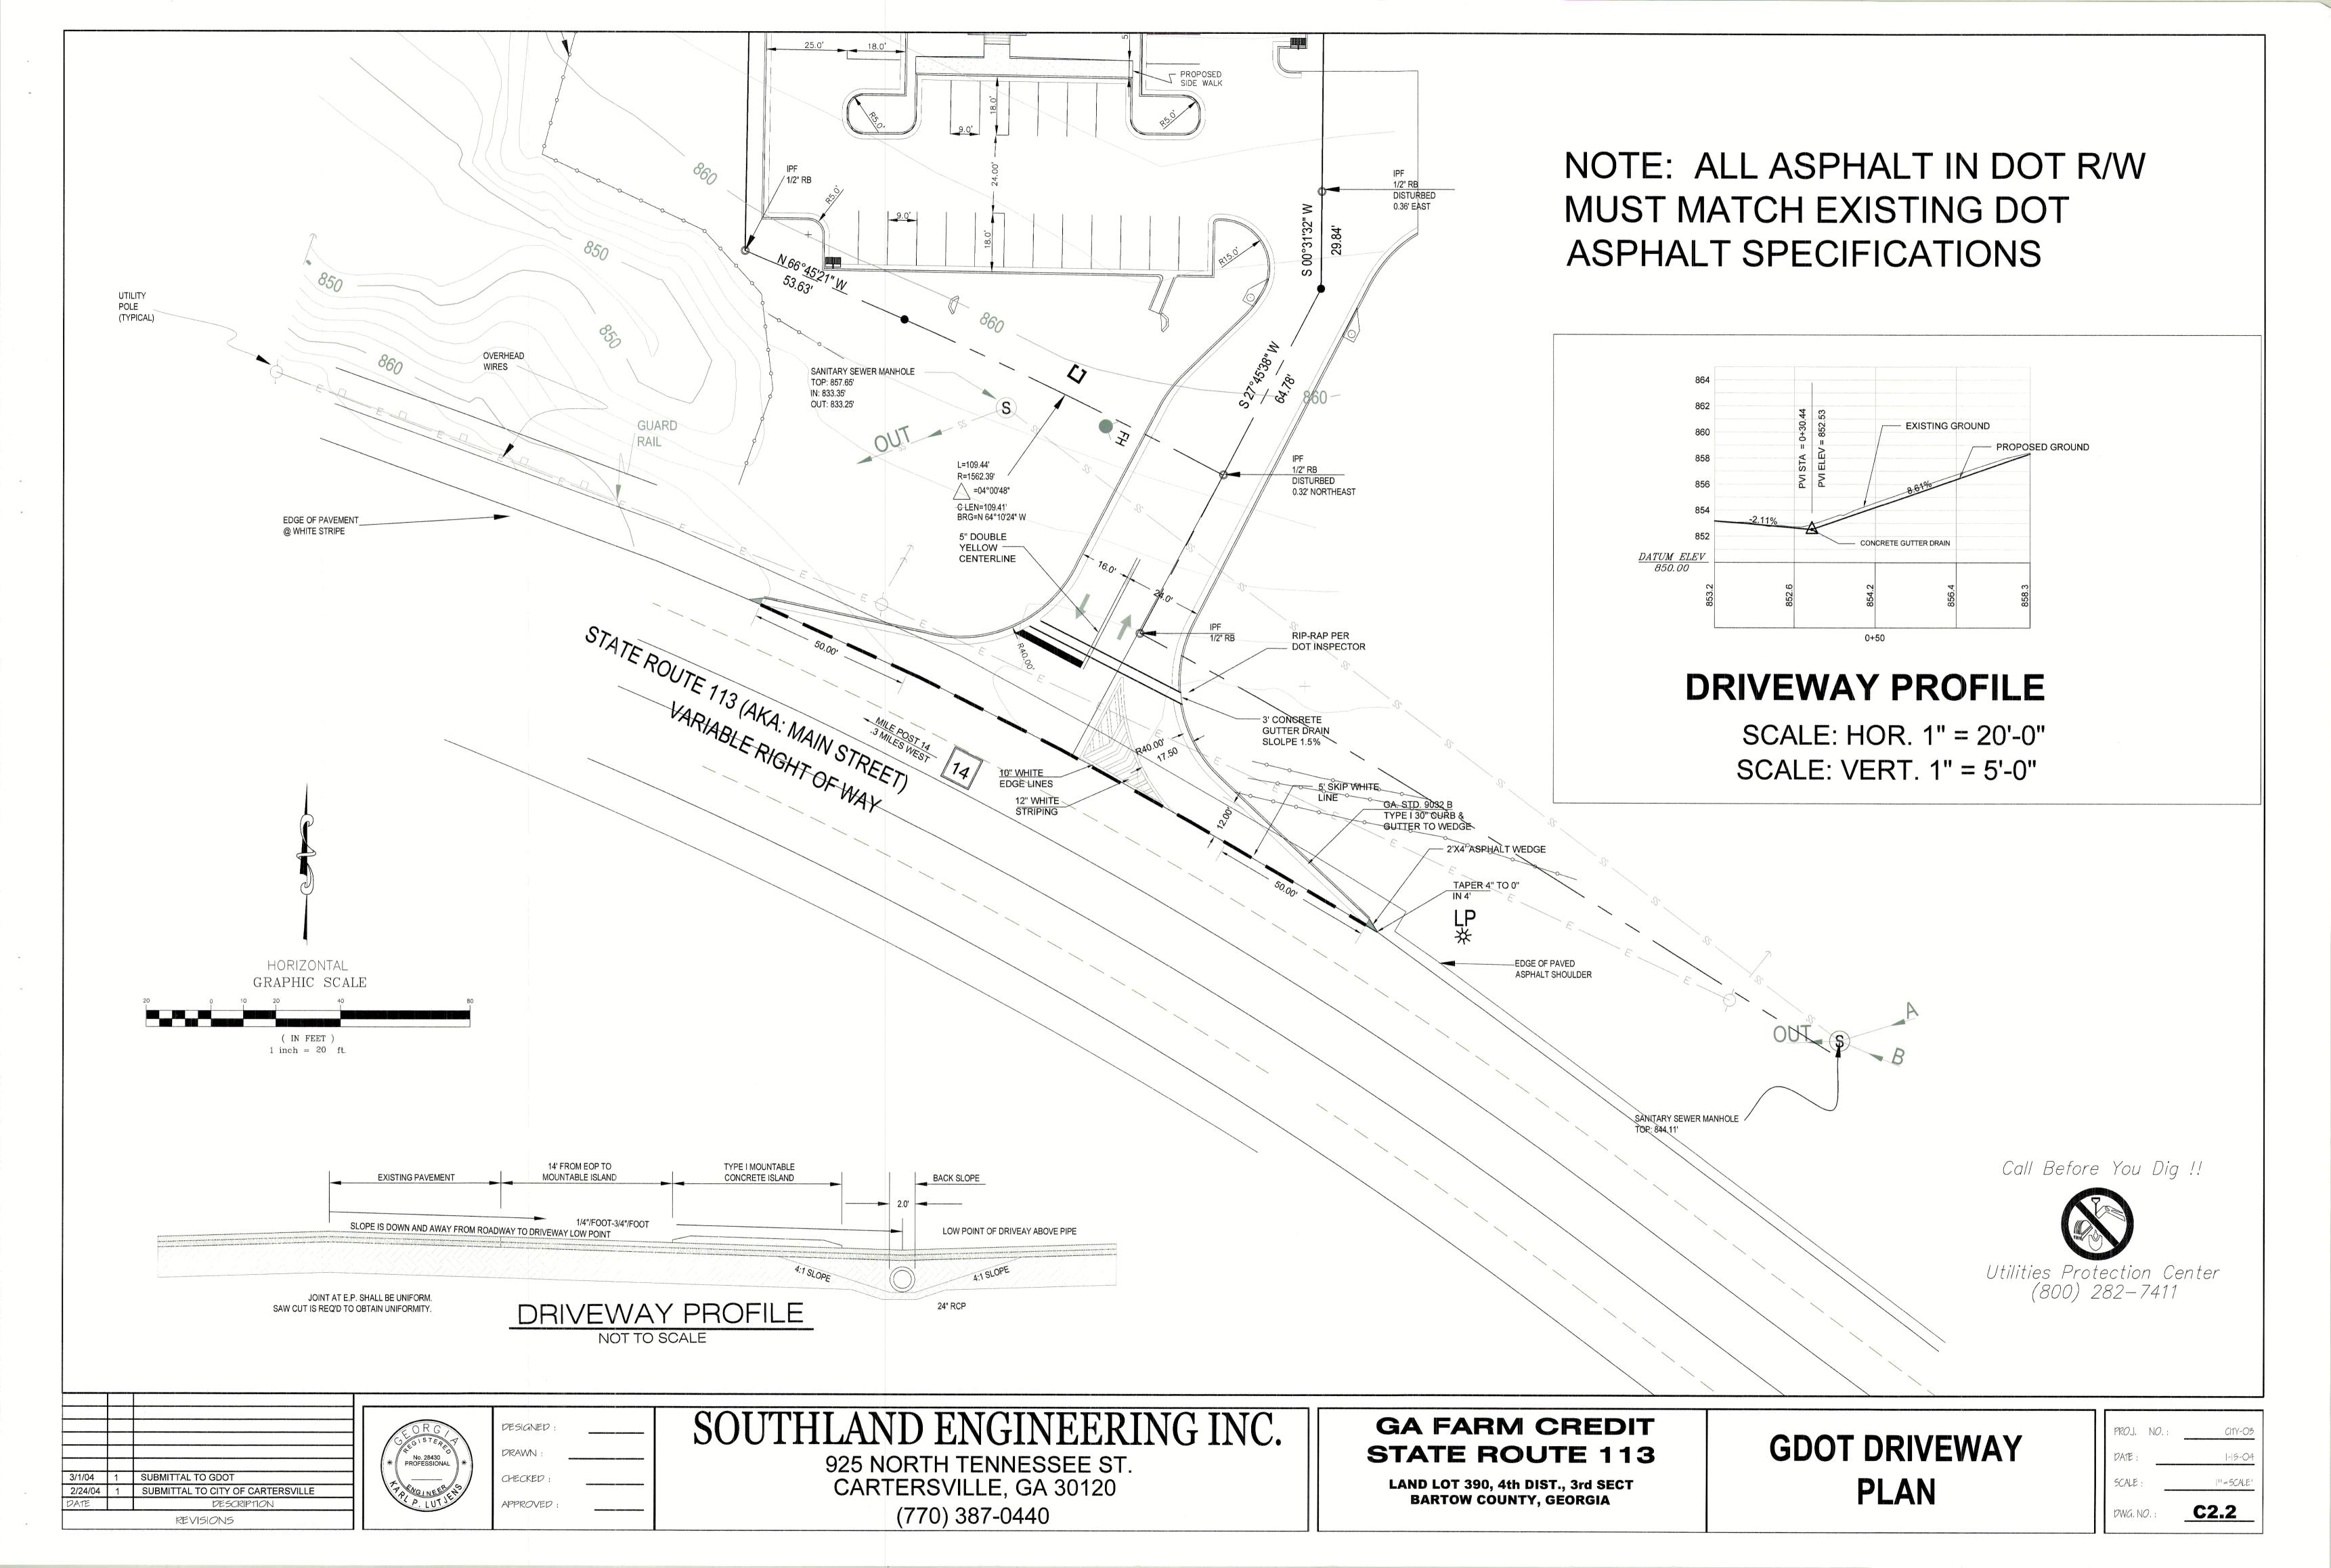

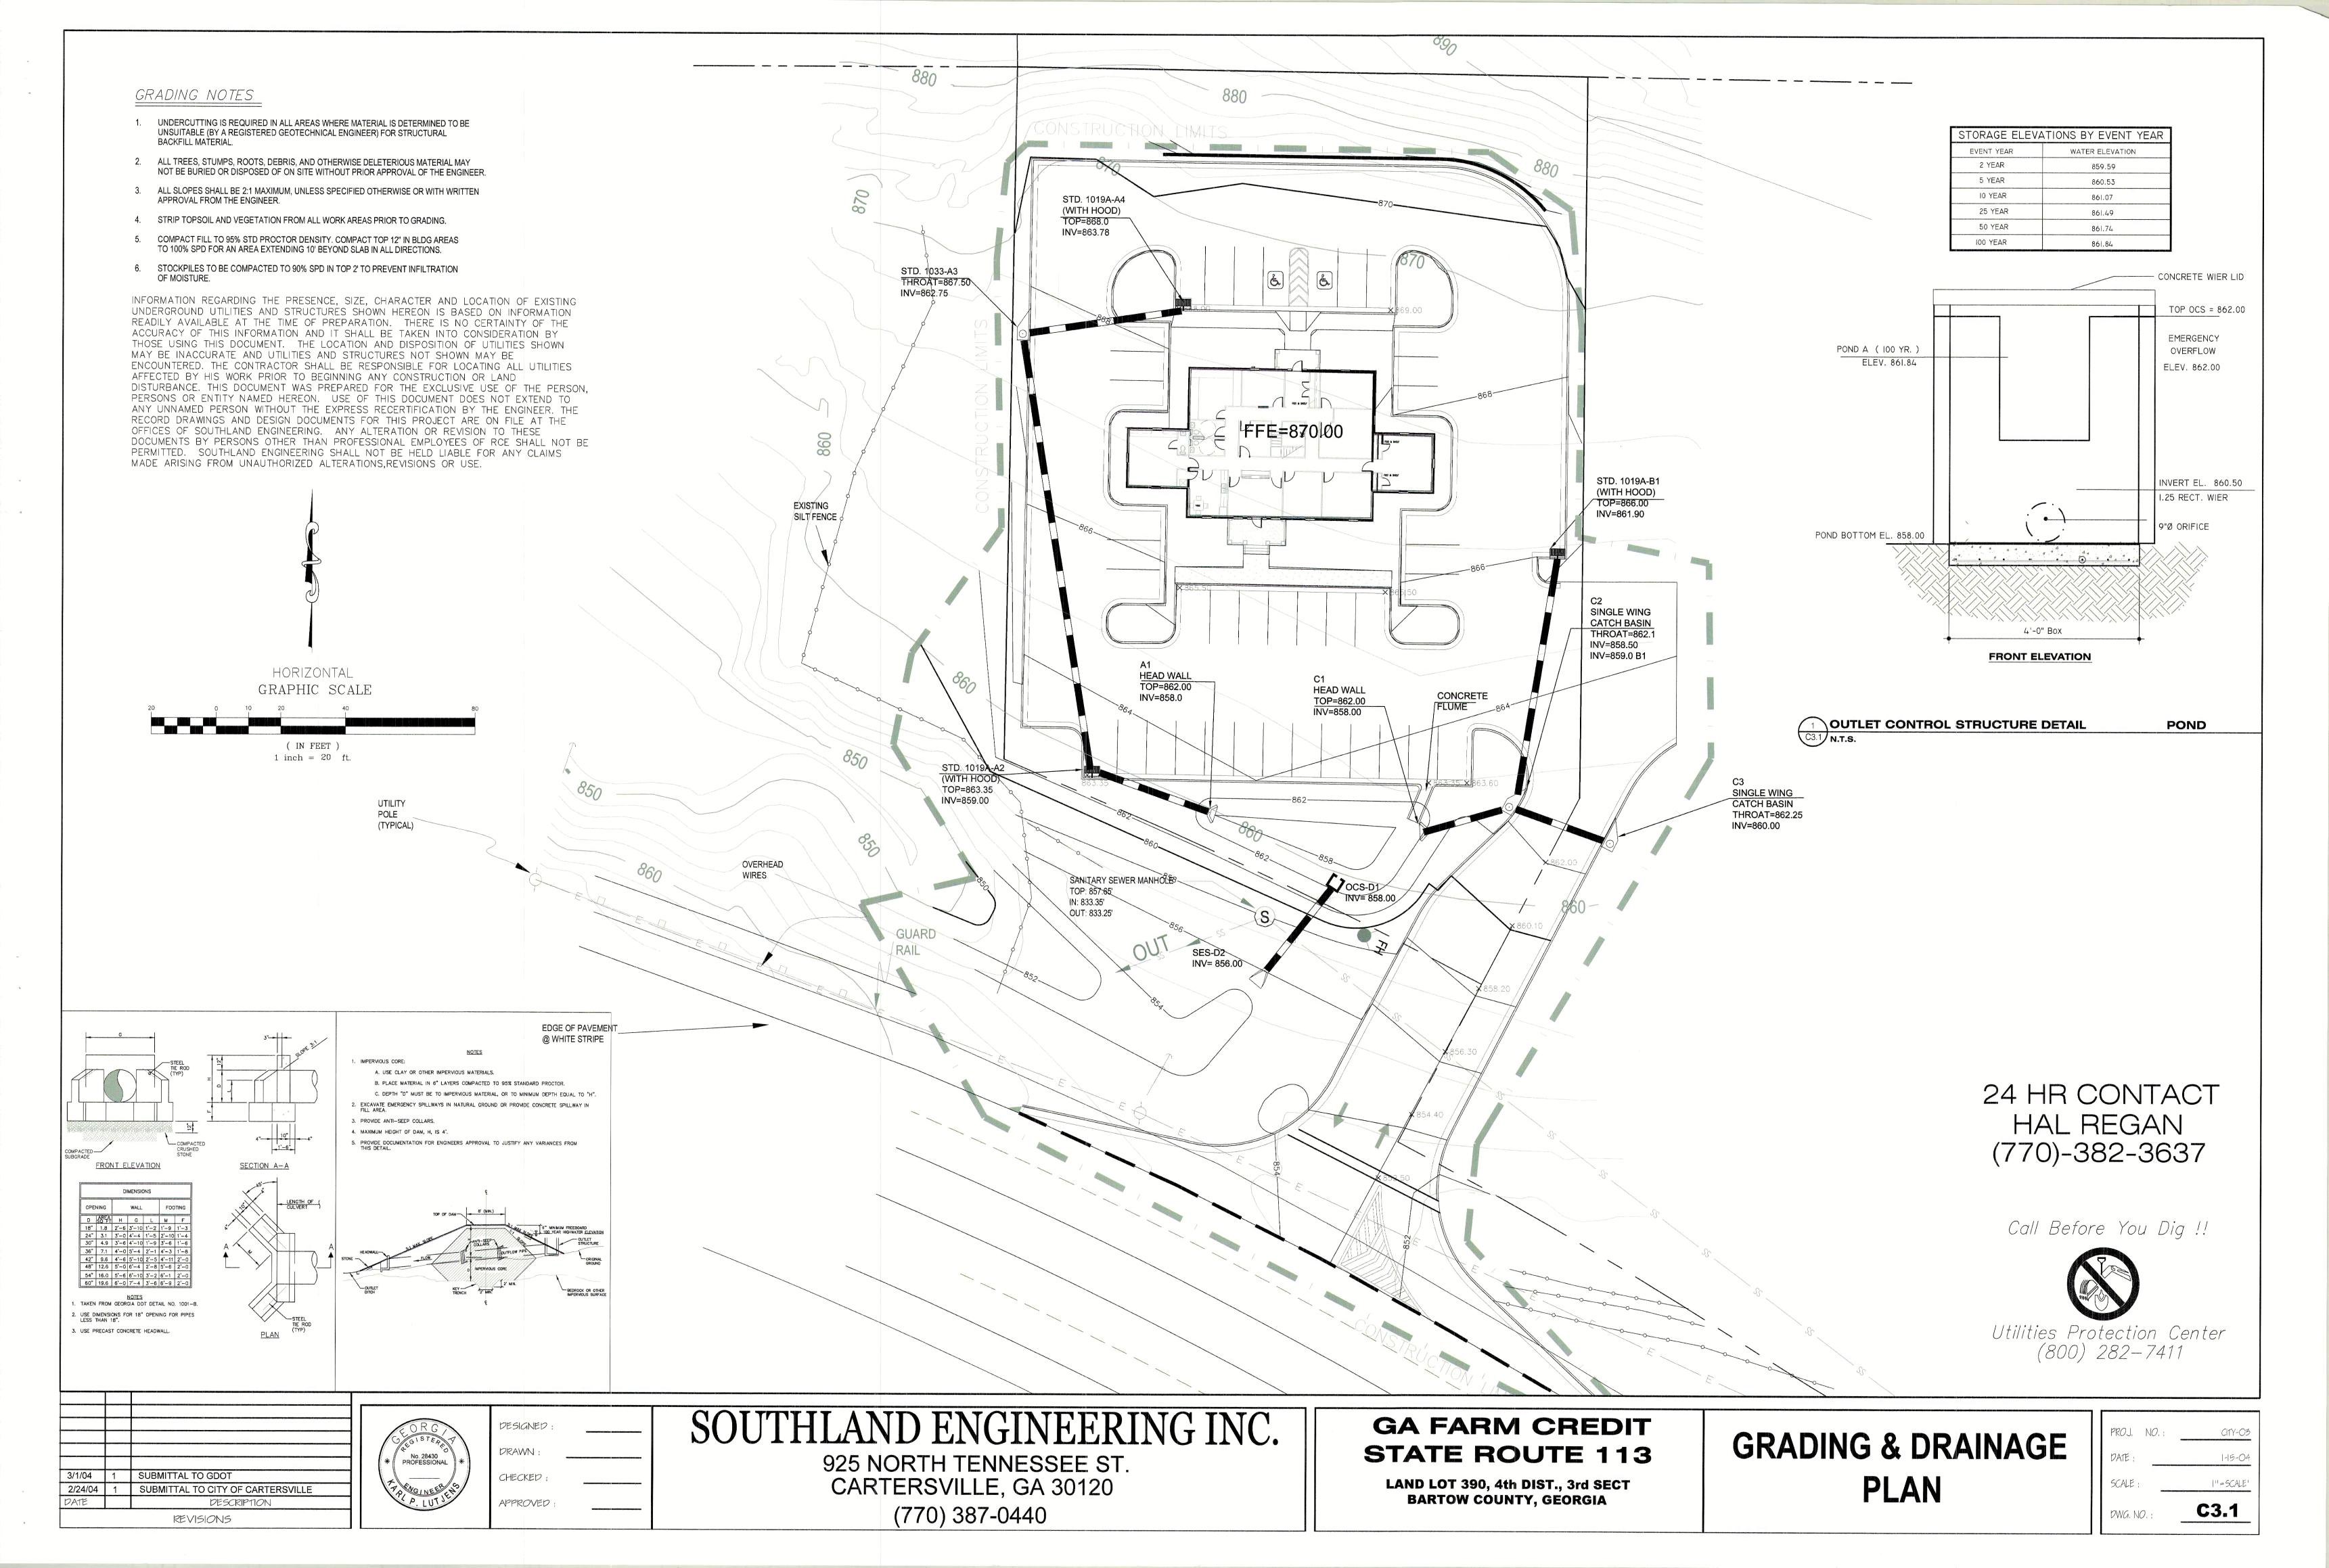

### SOIL EROSION AND SEDIMENT CONTROL NOTES

- 1. THE CONSTRUCTION PAD SHALL BE MAINTAINED IN A CONDITION WHICH WILL PREVENT TRACKING OR FLOW OF MUD ONTO PUBLIC STREETS.
- 2. SILT FENCES SHALL BE CLEANED OR REPLACED AND MAINTAINED IN FUNCTIONAL CONDITION UNTIL PERMANENT EROSION CONTROL MEASURES ARE ESTABLISHED.
- 3. SILT FENCE FABRIC SHALL MEET THE REQUIREMENTS OF SECTION 171-TEMPORARY SILT FENCES, OF THE DEPARTMENT OF TRANSPORTATION, STATE OF GEORGIA, STANDARD SPECIFICATIONS. 1983 EDITION 4. ALL GRASSING SHALL BE IN ACCORDANCE WITH CHAPTER 6, SECTION III "VEGETATIVE PRACTICES" OF THE MANUAL FOR EROSION AND SEDIMENT CONTROL IN GEORGIA.
- 5. ALL OTHER WORK SHALL BE PERFORMED IN ACCORDANCE WITH THIS SAME MANUAL. 6. THE CONTRACTOR SHALL FURNISH THE COUNTY WITH A SCHEDULE OF ANTICIPATED STARTING AND COMPLETION DATES FOR EACH SEQUENCE OF LAND DISTURBING ACTIVITY LISTED IN ITEMS ONE THROUGH
- 7. EROSION CONTROL DEVICES WILL BE IN PLACE BEFORE SITE DISTURBANCE AND WILL BE PERIODICALLY INSPECTED AND REPAIRED OR RESTORED AS NEEDED TO FUNCTION PROPERLY UNTIL PERMANENT
- MEASURES ARE ESTABLISHED AND PROJECT IS COMPLETE, I.E. CONSTRUCTION EXITS AND SILT FENCES SHALL BE RETOPPED OR OR CLEANED AS SILT REDUCES THEIR EFFECTIVENESS. 8. ANY ADDITIONAL CONSTRUCTION OTHER THAN SHOWN ON THIS PLAN WILL REQUIRE SEPARATE AND
- ADDITIONAL EROSION AND SEDIMENT CONTROL MEASURES AND APPROVAL 9. TEMPORARY VEGETATION AND/OR HEAVY MULCH WILL BE USED TO STABILIZE AREAS. IN NO CASE SHALL A SITE BE LEFT BARE FOR MORE THAN A MONTH.
- 10. ALL DISTURBED AREAS WILL BE PERMANENTLY LANDSCAPED AND GRASSED AS QUICKLY AS POSSIBLE. 11. ALL WORK SHALL BE PERFORMED IN ACCORDANCE WITH THE SPECIFICATIONS OF OF THE MANUAL FOR EROSION AND SEDIMENT CONTROL IN GEORGIA. DATES FOR EACH SEQUENCE OF LAND DISTURBING ACTIVITY
- 12. ALL DISTURBED AREAS WILL BE PERMANENTLY LANDSCAPED AND GRASSED AS QUICKLY AS POSSIBLE. 13. ADDITIONAL MEASURES WILL BE INSTALLED TO CONTROL EROSION AS DETERMINED BY COUNTY
- 14. EROSION CONTROL MEASURES WILL BE INSPECTED AT LEAST WEEKLY AND AFTER EACH RAIN, AND REPAIRED BY GENERAL CONTRACTOR.

#### EROSION CONTROL NOTES

- 1. ADDITIONAL EROSION CONTROL DEVICES TO BE USED AS REQUIRED BY COUNTY.
- 2. DISTURBED AREAS LEFT IDLE FOR FIVE (5) DAYS, AND NOT TO FINAL GRADE, WILL BE ESTABLISHED TO TEMPORARY VEGETATION (Ds1). DISTURBED AREAS LEFT IDLE FOR TWO WEEKS OR MORE WILL BE ESTABLISHED TO PERMANENT VEGETATION (Ds3). ALL AREAS TO FINAL GRADE WILL BE ESTABLISHED TO PERMANENT VEGETATION IMMEDIATELY UPON COMPLETION. WHEN HAND PLANTING, MULCH (HAY OR STRAW) SHOULD BE UNIFORMLY SPREAD OVER SEEDED AREA WITHIN 24 HOURS OF SEEDING. MULCH WILL BE USED AS A TEMPORARY COVER (Ds3). ON SLOPES THAT ARE GREATER THAN 2:1, MULCH, IF USED WILL BE ANCHORED.
- 3. AN APPROVED LAND DISTURBANCE PERMIT MUST BE DISPLAYED ON SITE AT ALL TIMES DURING CONSTRUCTION AND IN PLAIN VIEW FROM A COUNTY ROAD OR STREET.
- 4. EROSION AND SEDIMENT CONTROL DEVICES MUST BE INSTALLED AND INSPECTED PRIOR TO ANY GRADING ONSITE. PLEASE CALL (770) 528-2134 WITH ENOUGH LEAD TIME FOR AN INSPECTION TO MEET YOUR SCHEDULE.
- 5. SEDIMENT/EROSION CONTROL DEVICES MUST BE CHECKED AFTER EACH STORM EVENT. EACH DEVICE IS TO BE MAINTAINED OR REPLACED IF SEDIMENT ACCUMULATION HAS REACHED ONE HALF THE CAPACITY OF THE DEVICE. ADDITIONAL DEVICES MUST BE INTALLED IF NEW CHANNLELS HAVE DEVELOPED.
- 6. ALL SLOPES TO BE HYDROSEEDED AS SOON AS POSSIBLE.
- 7. THE ESCAPE OF SEDIMENT FROM THE SITE SHALL BE PREVENTED BY THE INSTALLATION OF EROSION AND SEDIMENT CONTROL MEASURES AND PRACTICES PRIOR TO, OR CONCURRENT WITH, LAND ACTIVITIES.
- 8. EROSION CONTROL MEASURES WILL BE MAINTAINED AT ALL TIMES. IF FULL IMPLEMENTATION OF THE APPROVED PLAN DOES NOT PROVIDE FOR EFFECTIVE EROSION CONTROL, ADDITIONAL EROSION AND SEDIMENT CONTROL MEASURES SHALL BE IMPLEMENTED TO CONTROL OR TREAT THE SEDIMENT SOURCE.

#### **ACTIVITY SCHEDULE**

ACIIVIII	BCILDUL
ACTIVITY	DATES
EROSION CONTROL FENCE	4/01/04
STORMWATER MGM'T FACILITIES	WEEK 1
SITE DEMOLITION/CLEARING	WEEK 1-2
GRADING, DRAINAGE & UTILITIES	WEEK 1-2
BUILDING CONSTRUCTION	WEEK 5-14
PAVEMENT RESURFACING	WEEK 15
LANDSCAPING/EROSION CONTROL	WEEK 16-END

NOTES: 1. ALL AREAS TO BE SEEDED SHALL HAVE LIME APPLIED AT A RATE OF 90 LB/1000 SF. LIME AND FERTILIZER TO BE APPLIED PRIOR TO APPLICATION OF SEED AND MIXED THOROUGHLY WITH SOIL. 2. ALL AREAS SEEDED SHALL HAVE AN APPLICATION OF STRAW MULCH IMMEDIATELY AFTER APPLICATION OF FERTILIZER REGARDLESS OF PLANTING METHOD AT THE RATE OF APPROXIMATELY 2 TONS PER ACRE 3. LAND STABILIZATION BY TEMPORARY AND/OR PERMANENT COVER WILL BEGIN AS QUICKLY AS POSSIBLE WITHIN 21 DAYS OF THE COMMENCEMENT OF

GRADING.

#### EROSION CONTROL LEGEND

CONSTRUCTION ENTRANCE/EXIT

SEDIMENT BARRIER

SEDIMENT PROTECTION

(WITH MULCHING ONLY) DISTURBED AREA STABILIZATION (WITH TEMPORARY SEEDING)

DISTURBED AREA STABILIZATION (WITH PERMANENT VEGETATION)

DISTURBED AREA STABLIZATION

### TEMPORARY SEDIMENT BASIN A

- 1. Drainage Area=.68ac
- Required Sediment Storage = 67 cy/ac \* drainage area Required Sediment Storage = 67 cy \* .68 ac = 45.56 cy Required Sediment Storage = 45.56 cy = 1230.12 cf
   Assume Excavation Depth (minimum 1.5 ft.) = 2.0 ft
   Assume Slope of Sides (2:1 max) = 3:1
- 5. Determine Required Surface Area SAmin = Required Sediment Storage / Excavated Depth SAmin = 1230.12 / 2.0 ftSAmin = 615.06 sf
- 6. Assume Shape of excavation and determine dimensions.

  (A triangle shape with 2:1 length to width ratio is recommended) Shape: TRIANGLE Dimensions: SEE PLAN

# SUBMITTAL TO GDOT SUBMITTAL TO CITY OF CARTERSVILLE DESCRIPTION

**REVISIONS** 



DESIGNED DRAWN CHECKED

APPROVED :

# SOUTHLAND ENGINEERING INC.

925 NORTH TENNESSEE ST. CARTERSVILLE, GA 30120 (770) 387-0440

### **GA FARM CREDIT STATE ROUTE 113**

LAND LOT 390, 4th DIST., 3rd SECT BARTOW COUNTY, GEORGIA

# **EROSION CONTROL PLAN**

	DWG. NO. :	
	SCALE :	I'I=SCALE'
	DATE:	1-15-04
	PROJ. NO.:	CITY-03
١.		



#### DETENTION POND MAINTENANCE

All detention ponds will remain the property and responsibility of the owner/developer who receives the initial permit for development of the property. The owner/developer shall be responsible for all inspection, maintenance, and repair of the facility.

#### INSPECTION

Inspect detention pond for erosion and any changes after every major storm event but at least monthly. Inspect embankments for any visible signs of erosion, seepage, sloughing, sliding, or other instability. Inspect outlet structures for flow obstructions, cracks, vandalism, or erosion. Notify CITY Engineer of any observed problems.

#### REGULAR MAINTENANCE

prevent future recurrence.

\* Proceed with corrective measures for observed problems immediately or as soon as weather conditions

- \* Maintain good grass cover at all times. Fertilize grass according to type of grass and recommended
- \* Mow grass as required. Remove undesirable vegetation such as trees, bushes, vines, and briars. \* Fill all eroded gullies and vehicle ruts and compact soil. Backfill any hollow spots under concrete spillways or outlet structures and compact soil. Replace any riprap that has washed away from spillways and pipe outlets. Determine the cause of any slides or sloughs and repair. Take corrective action to
- \* Remove all trash, debris, tree limbs, or other flow obstructions from detention pond, outlet structures, and pipes. Fill all animal burrows and compact soil. Repair vandalism. Maintain pond and outlet
- structures in good working order.
- \* Inspect fence and repair as necessary.
- \* Inspect pond after every 1/2" rainfall within 24 hours.


Remove vegetation from any cracks in concrete spillways or outlet structures and seal with mastic joint filler. Lubricate and test moving parts on gates, valves, etc. Repair metal parts to prevent rust. Replace badly rusted parts. Remove any accumulated sediment to restore pond to design volume. Reseed or resod grass as necessary to maintain good vegetative cover.

#### UTILITIES PROTECTION CENTER




THREE WORKING DAYS BEFORE YOU DIG


CONTRACTOR TO PROVIDE MULCH TEMPORARY VEGETATION, OR PERMANENT VEGETATION ON ALL EXPOSED AREAS WITHIN 14 DAYS AFTER DISTURBANCE.

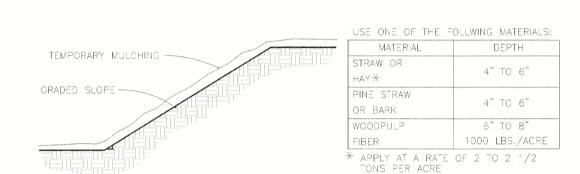




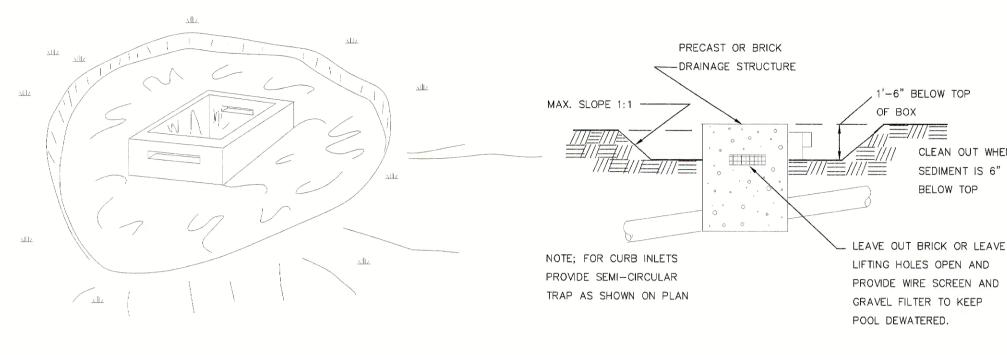



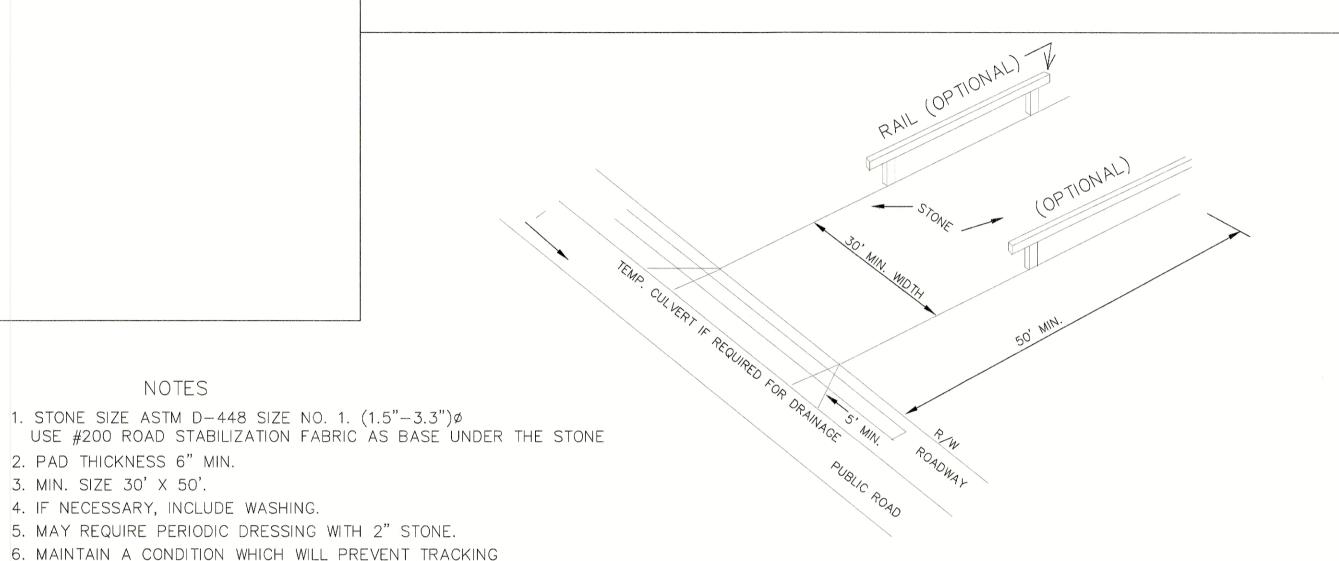



CONSTRUCTION ENTRANCE / EXIT

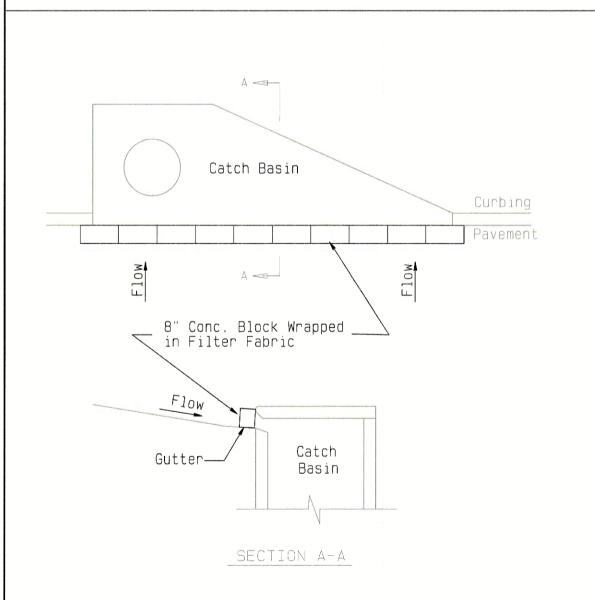


Note: Install Filter After Any Asphalt Pavement Installatio



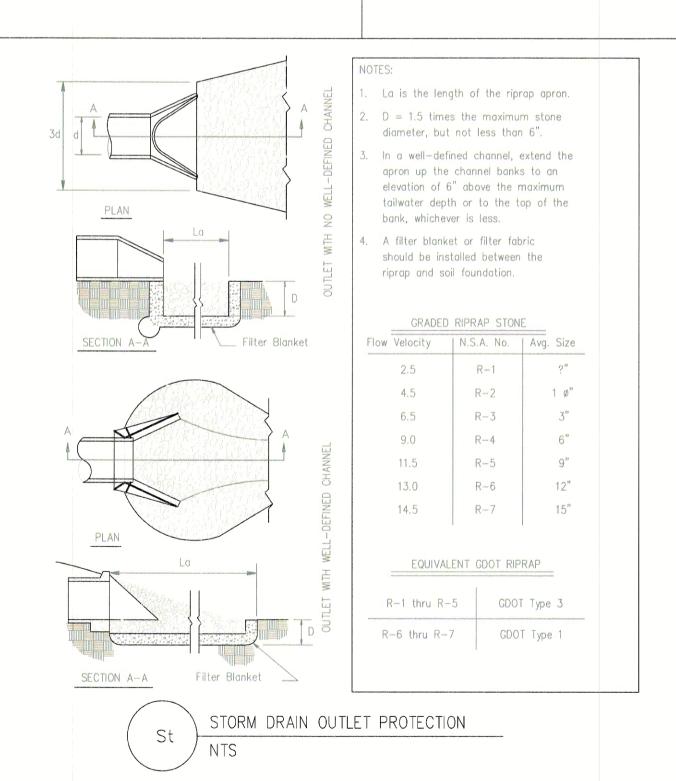

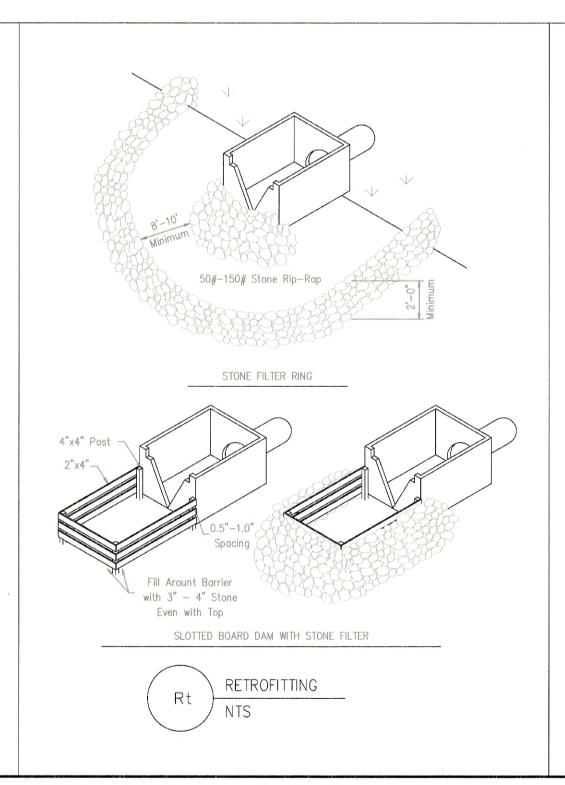

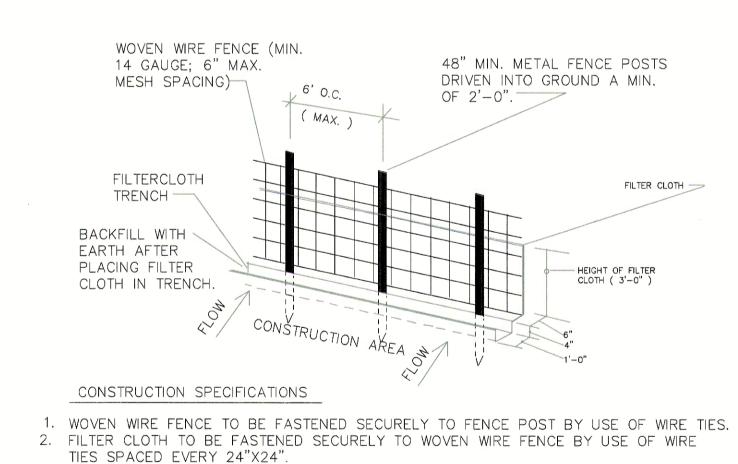


SILT FENCES TO BE INSTALLED IN LOCATIONS AS SHOWN ON THIS EROSION AND SEDIMENT CONTROL PLAN PRIOR TO BEGINNING OF CONSTRUCTION TO CONTROL

4. SILT FENCE TO BE MAINTAINED AND CLEANED AS NECESSARY TO MAINTAIN IN FUNCTIONAL CONDITION.

SILT FENCES TO BE REMOVED AND THE AREA TO BE RESTORED TO ITS NATURAL CONDITION WHEN PERMANENT EROSION AND SEDIMENT CONTROL PROCEDURES ARE EFFECTIVE.



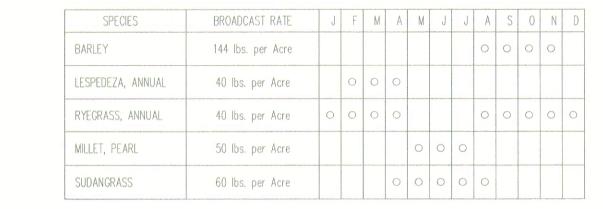


TYPE OF SPECIES	AGRICULTURAL LIME	STRAW MULCH	YEAR	N-P-K	RATE
	4 T	500 lbs	First	10-10-10	500 lbs per Ac.
COOL SEASON GRASSES	1 Ion		Second	added spirits startly access	Marie which again never rates with more
	per Acre	per Acre	Maintenance	distribution of the state of th	
TEMPORARY COVER CROPS	N/A	N/A	First	10-10-10	500 lbs per Ac.
	4 T	500 lba	First	10-10-10	500 lbs per Ac.
WARM SEASON GRASSES	1 Ion	500 lbs	Second	time dance with more	the same with some way the same
THE SELECTION OF THE SE	per Acre	per Acre	Maintenance		House Mark will have and the second second second second

TEMPORARY VEGATATIVE COVER PLANTING RATES AND DATES


TYPE OF SPECIES	AGRICULTURAL	STRAV			YEAR		N-	P-K			RAT	E	eronius irrain an
LESPEDEZA, SERICEA	60 lbs. per Acre			0	0	0	0						
FESCUE, TALL	50 lbs. per Acre				months are a set of balleting				0	0	0		
BERMUDA, COMMON (Unhulled Seed)	10 lbs. per Acre	0	0								0	0	
BERMUDA, COMMON (Hulled Seed)	10 lbs. per Acre			0	0	0	0				and the second second		
BAHIA, PENSACOLA BAHIA, WILMINGTON	60 lbs. per Acre	0	0	0	0	0	0	0	0	0	0	0	(
SPECIES	BROADCAST RATE	J	F	М	Α	М	J	J	Α	S	0	N	- Cartina

TYPE OF SPECIES	AGRICULTURAL LIME	STRAW MULCH	YEAR	N-P-K	RATE
COOL SEASON GRASSES	1 — 2 Tons per Acre	2 Tons per Acre	First Second Maintenance	6-12-12 6-12-12 10-10-10	1500 lbs per Ac. 1000 lbs per Ac. 400 lbs per Ac.
TEMPORARY COVER CROPS	N/A	N/A	First	10-10-10	500 lbs per Ac.
WARM SEASON GRASSES	1 – 2 Tons per Acre	2 Tons per Acre	First Second Maintenance	6-12-12 6-12-12 10-10-10	1500 lbs per Ac. 800 lbs per Ac. 400 lbs per Ac.

PERMANENT VEGATATIVE COVER

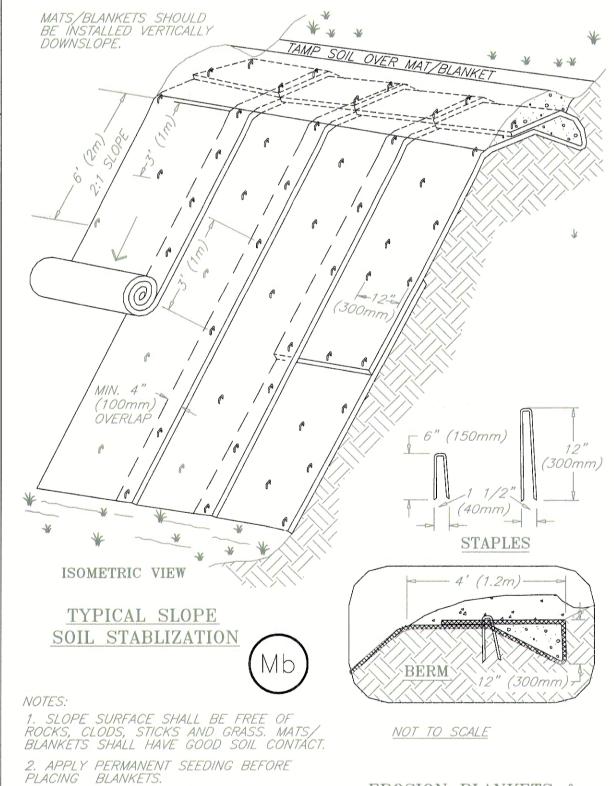

3. LAY BLANKETS LOOSELY AND STAKE OR STAPLE TO MAINTAIN DIRECT CONTACT WITH TURF REINFORCEMENT MATS

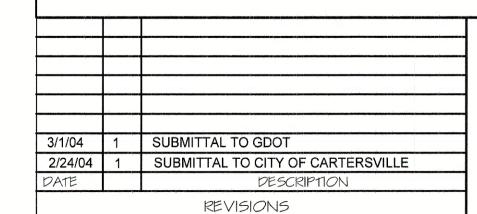



DESIGNED DRAWN: CHECKED

APPROVED:

# SOUTHLAND ENGINEERING INC.

NOTES

4. IF NECESSARY, INCLUDE WASHING.

5. MAY REQUIRE PERIODIC DRESSING WITH 2" STONE.

OR FLOW OF MUD ONTO PUBLIC ROAD.

2. PAD THICKNESS 6" MIN.

3. MIN. SIZE 30' X 50'.

925 NORTH TENNESSEE ST. CARTERSVILLE, GA 30120 (770) 387-0440

### GA FARM CREDIT **STATE ROUTE 113**

LAND LOT 390, 4th DIST., 3rd SECT BARTOW COUNTY, GEORGIA


# **EROSION CONTROL DETAILS**

THE SOIL. DO NOT STRETCH.


DATE: 1-15-0	DWG, NO. ;	C4.2
mangan ng Program da ang mangan ng mangang mangang mangang mangang mangang mangang mangang mangang mananang ma Tanggan ng mangang man	SCALE :	"=SCAL
PROJ. NO.: CITY-C	DATE :	1-15-0
	PROJ. NO.	CITY-C

EROSION BLANKETS &

SLOPE INSTALLATION

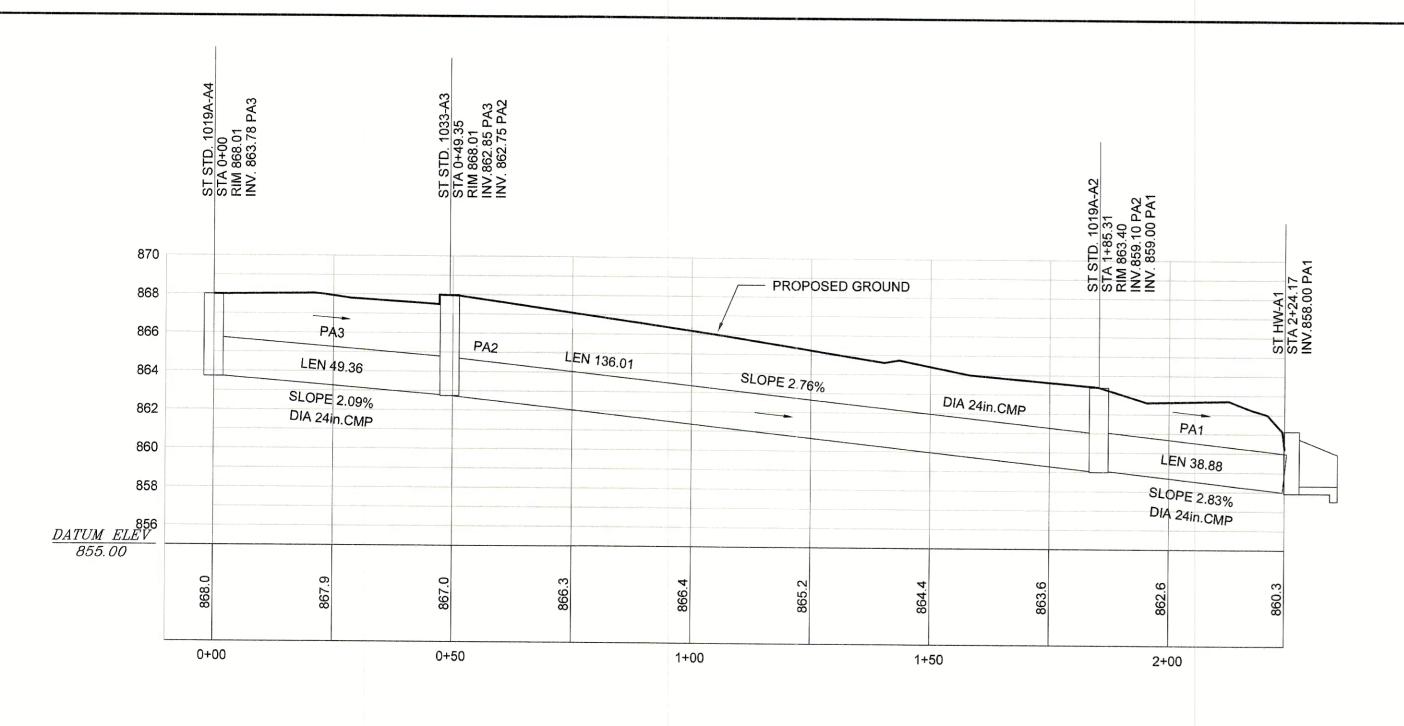


# 

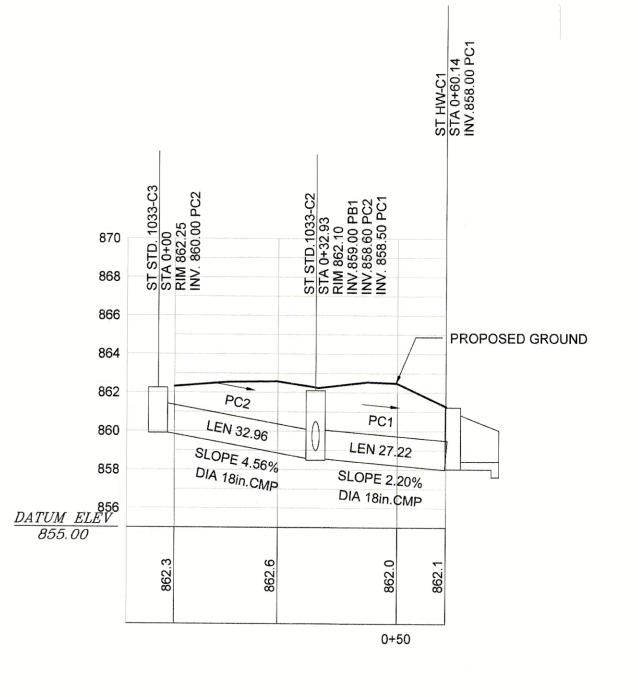

### STORM SEWER A PROFILE

SCALE: HOR. 1" = 20'-0" SCALE: VERT. 1" = 5'-0"

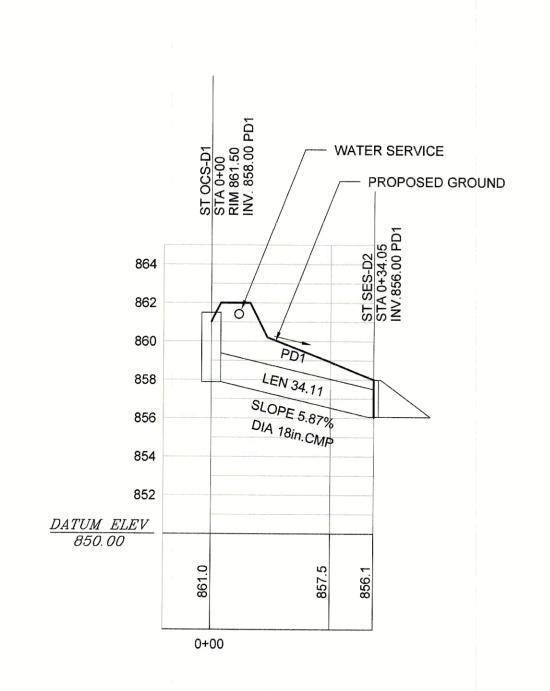


### STORM SEWER A PROFILE

SCALE: HOR. 1" = 20'-0" SCALE: VERT. 1" = 5'-0"

## STORM SEWER B PROFILE

SCALE: HOR. 1" = 20'-0" SCALE: VERT. 1" = 5'-0"

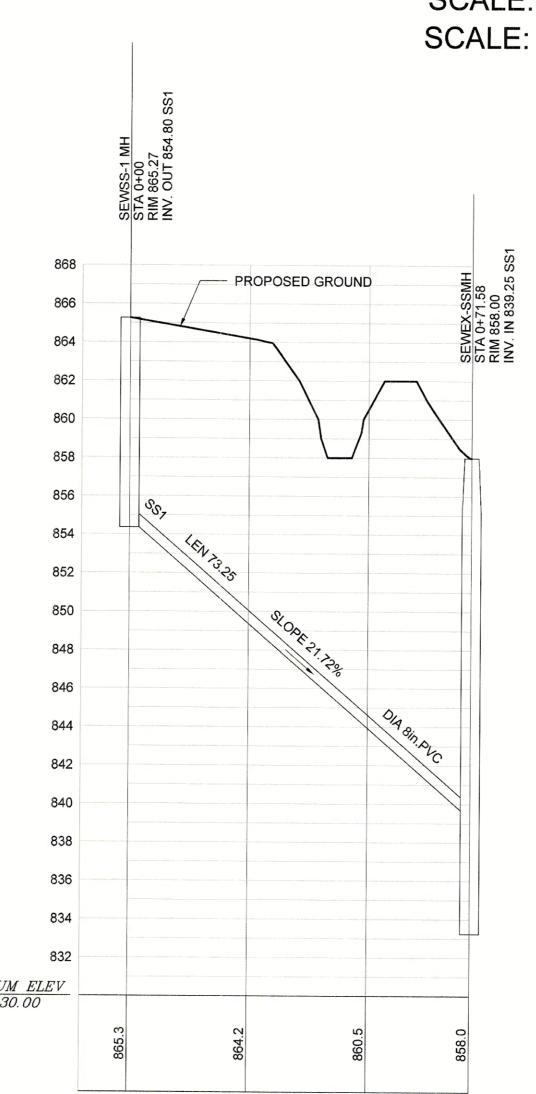

### STORM SEWER C PROFILE

SCALE: HOR. 1" =20'-0" SCALE: VERT. 1" = 5'-0"

# SANITARY SEWER SS-1 PROFILE

SCALE: HOR. 1" = 20'-0" SCALE: VERT. 1" = 5'-0"

3/1/04 1 SUBMITTAL TO GDOT
2/24/04 1 SUBMITTAL TO CITY OF CARTERSVILLE
DATE DESCRIPTION
REVISIONS



DESIGNED:

DRAWN:

CHECKED:

APPROVED:


# SOUTHLAND ENGINEERING INC.

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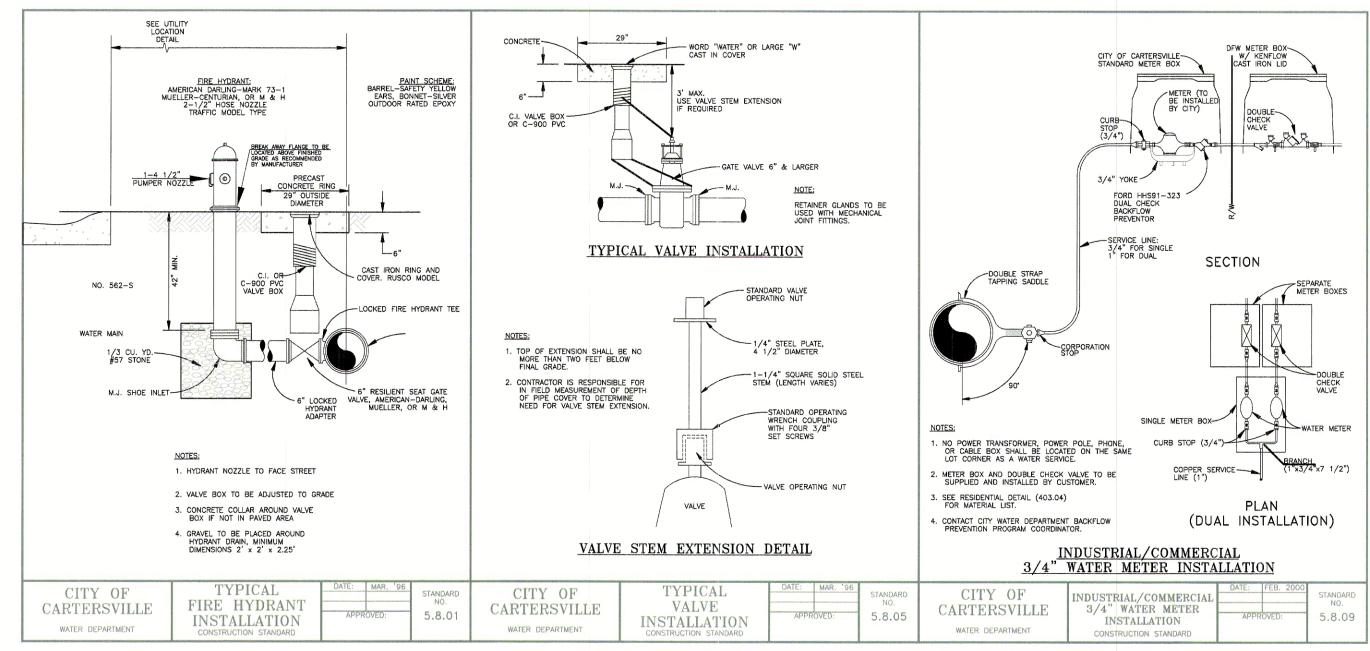
### GA FARM CREDIT STATE ROUTE 113


LAND LOT 390, 4th DIST., 3rd SECT BARTOW COUNTY, GEORGIA STORM & SEWER PROFILES

DWG. NO. :	C5.1
SCALE :	I''=SCALE'
DATE	1-15-04
PROJ. NO.:	CITY-03



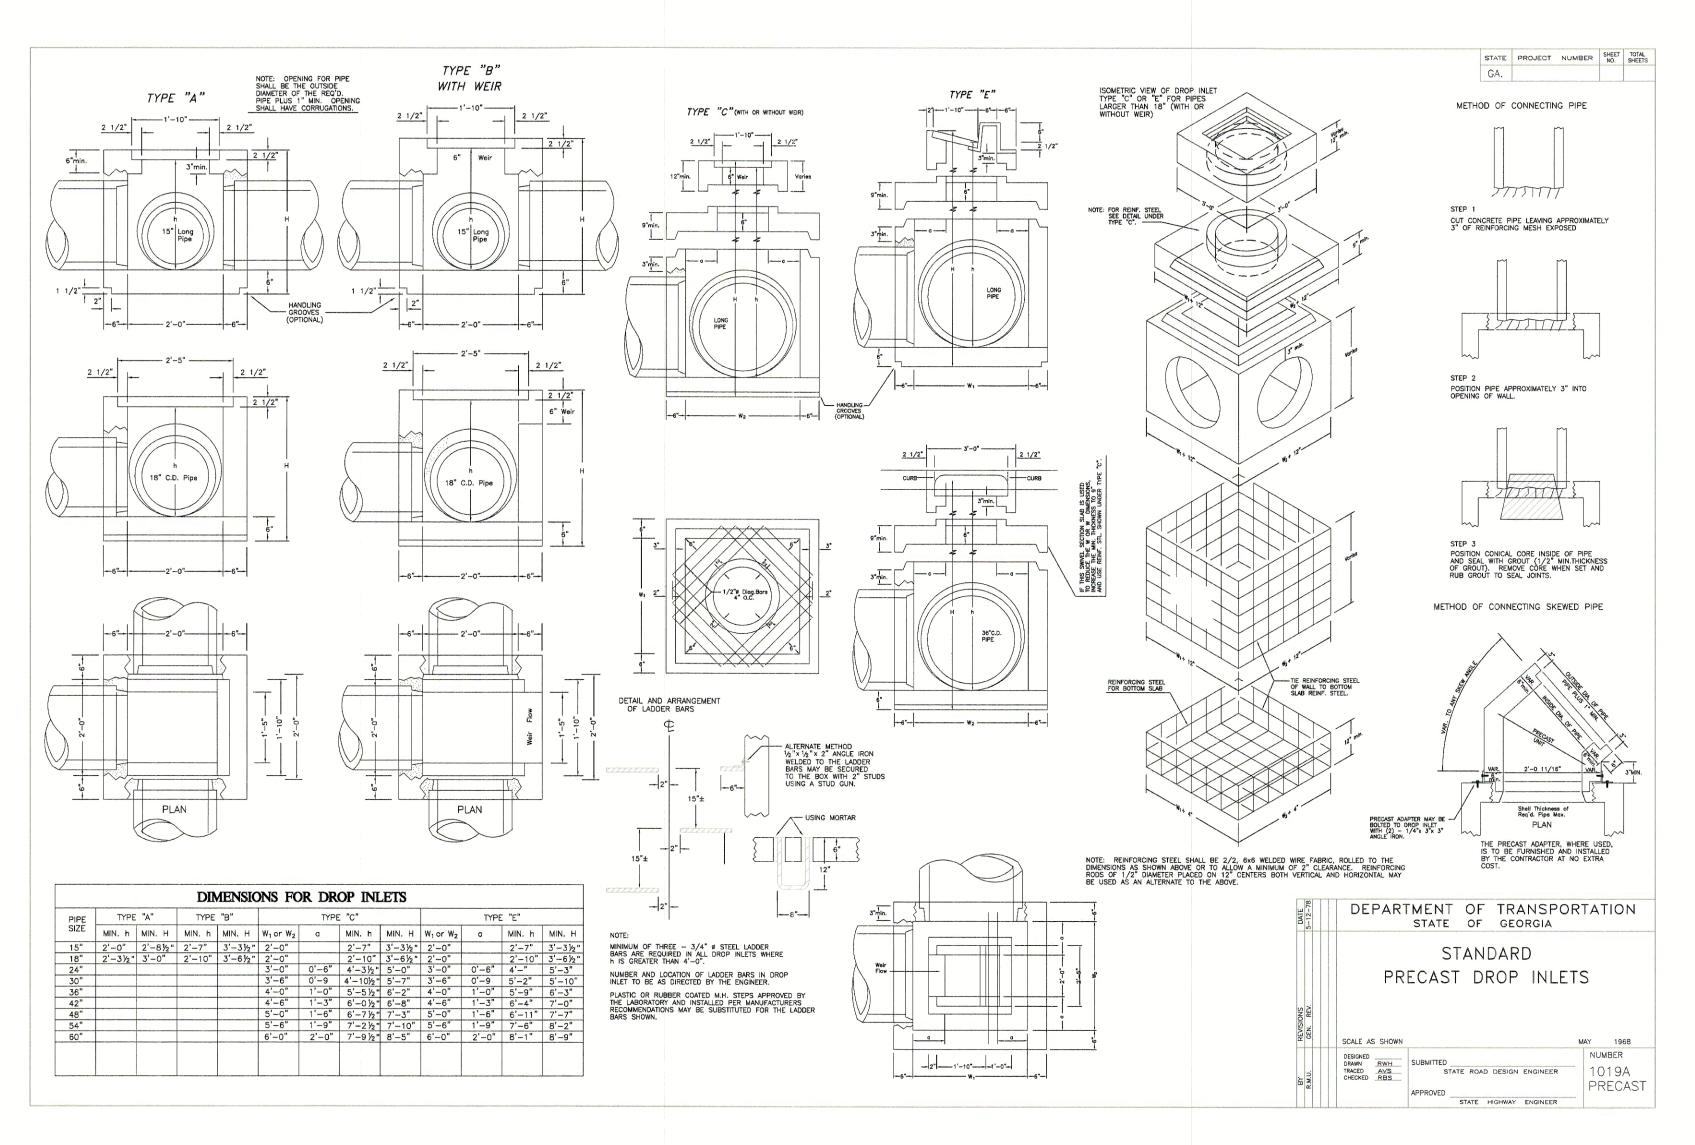




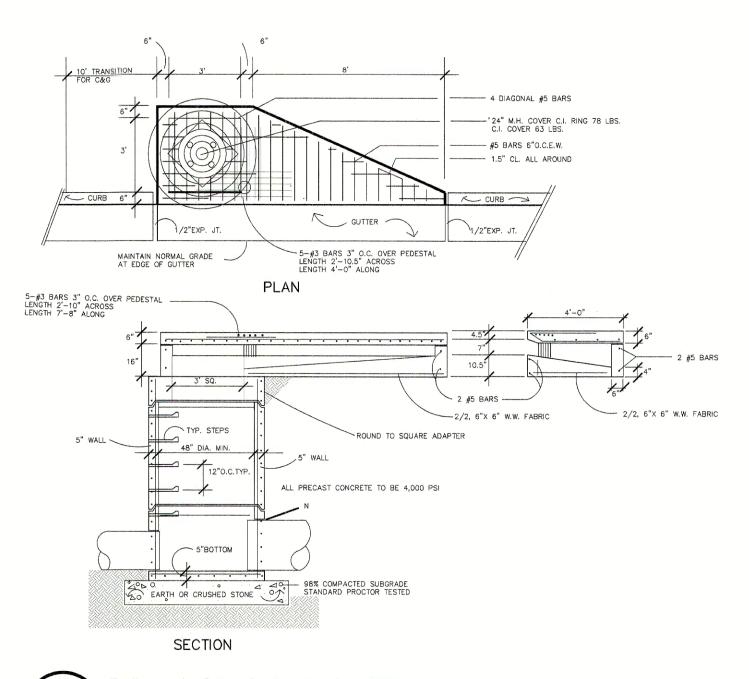

3 STD. DOT CURB INLET 1033
C6.1 NOT TO SCALE

-		
3/1/04	1	SUBMITTAL TO GDOT
2/24/04	1	SUBMITTAL TO CITY OF CARTERSVILLE
PATE		DESCRIPTION

**REVISIONS** 

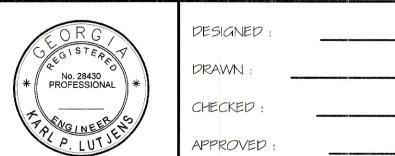

# SOUTHLAND ENGINEERING INC.

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### GA FARM CREDIT STATE ROUTE 113

LAND LOT 390, 4th DIST., 3rd SECT BARTOW COUNTY, GEORGIA

# TYPICAL DETAILS

PROJ. NO.:	CITY-03 1-15-04
SCALE:	"=SCALE
DWG. NO. :	C6.1